Request for Proposal Number: <u>23-24</u>

Addendum 3 Date: March 14, 2023

Acknowledgment of Addenda

The undersigned acknowledges receipt of the following addenda to the bidding document:

THE COMPLETED ACKNOWLEDGEMENT OF ADDENDA FORM SHOULD BE RETURNED WITH BID RESPONSE PACKAGE: NOT SENT TO RIPTA SEPARATELY

NOTE: Failure to acknowledge receipt of all addenda may cause the bid to be

considered non-responsive to the solicitation. Acknowledged receipt of each addendum must be clearly established and included with the bid.
Name of Bidder
Street Address
City, State, Zip
Signature of Authorized Official
Date Date

Request for Proposal Number: 23-24

Addendum 3
Date: March 14, 2023

<u>CCRI Warwick Enhanced Bus Service Project – RFP No. 23-24</u> <u>Addendum 3</u>

Date: March 14, 2023

Notice to Prospective Bidders:

Prospective bidders and all concerned are hereby notified of the following changes in the Plans, Specifications, Proposal and Distribution of Quantities for this contract. These changes

shall be incorporated in the Plans, Specifications, Proposal and Distribution of Quantities, and

shall become an integral part of the Contract Documents.


Description of Changes:

Addendum No. 3 includes the following:

- 1. Revision to Contract Plan Sheets
 - a. C-001 Civil Notes
 - b. C-021 Site Preparation Plan
 - c. C-101 Site Plan
 - d. C-111 Grading & Drainage Plan
 - e. C-121 Signing & Pavement Marking Plan
 - f. C-131 Location Plan
 - g. C-142 Landscape Plan
 - h. C-201 Construction Profile
 - i. C-301 Cross Sections
 - i. C-302 Cross Sections
 - k. C-303 Cross Sections
 - I. C-304 Cross Sections
 - m. C-501 Civil Details
- 2. Revision to Contract Specifications
 - a. N/A

IND	EX OF DRAWINGS
DRAWING NO.	DRAWING TITLE
G-001	COVER
C-001	CIVIL NOTES
C-002	CIVIL SYMBOLS, LEGEND, & ABBREVIATIONS
C-003	TYPICAL SECTIONS
C-004	BORING LOGS
C-011	EXISTING CONDITIONS PLAN
C-021	SITE PREPARATION PLAN
C-101	SITE PLAN
C-111	GRADING & DRAINAGE PLAN
C-121	SIGNING & PAVEMENT MARKING PLAN
C-131	LOCATION PLAN
C-141	LANDSCAPE PLAN
C-142	LANDSCAPE PLAN
C-201	PROFILE
C-301 - C-304	CROSS SECTIONS
C-401	BUS SHELTER PLAN & ELEVATION
C-402	SITE RAMP
C-501	CIVIL DETAILS
C-502	CIVIL DETAILS
C-503	CIVIL DETAILS
C-504	CIVIL DETAILS
C-505	CIVIL DETAILS
C-506	CIVIL DETAILS
C-511	LANDSCAPE DETAILS



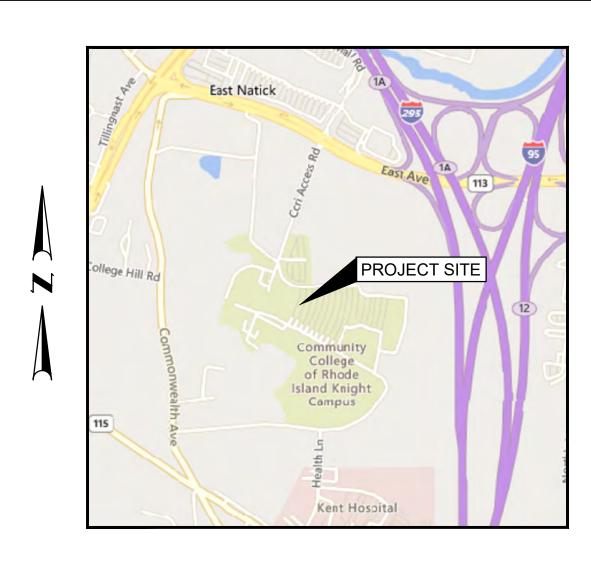


LOCATION MAP

RIPTA-CCRI ENHANCED BUS SERVICE PROJECT

CCRI KNIGHTS CAMPUS


400 EAST AVENUE - WARWICK, RI 02886 COUNTY OF KENT


R.I. CONTRACT NO. 2022-XX-XXX RIFAP NO. XXXXXXXXX

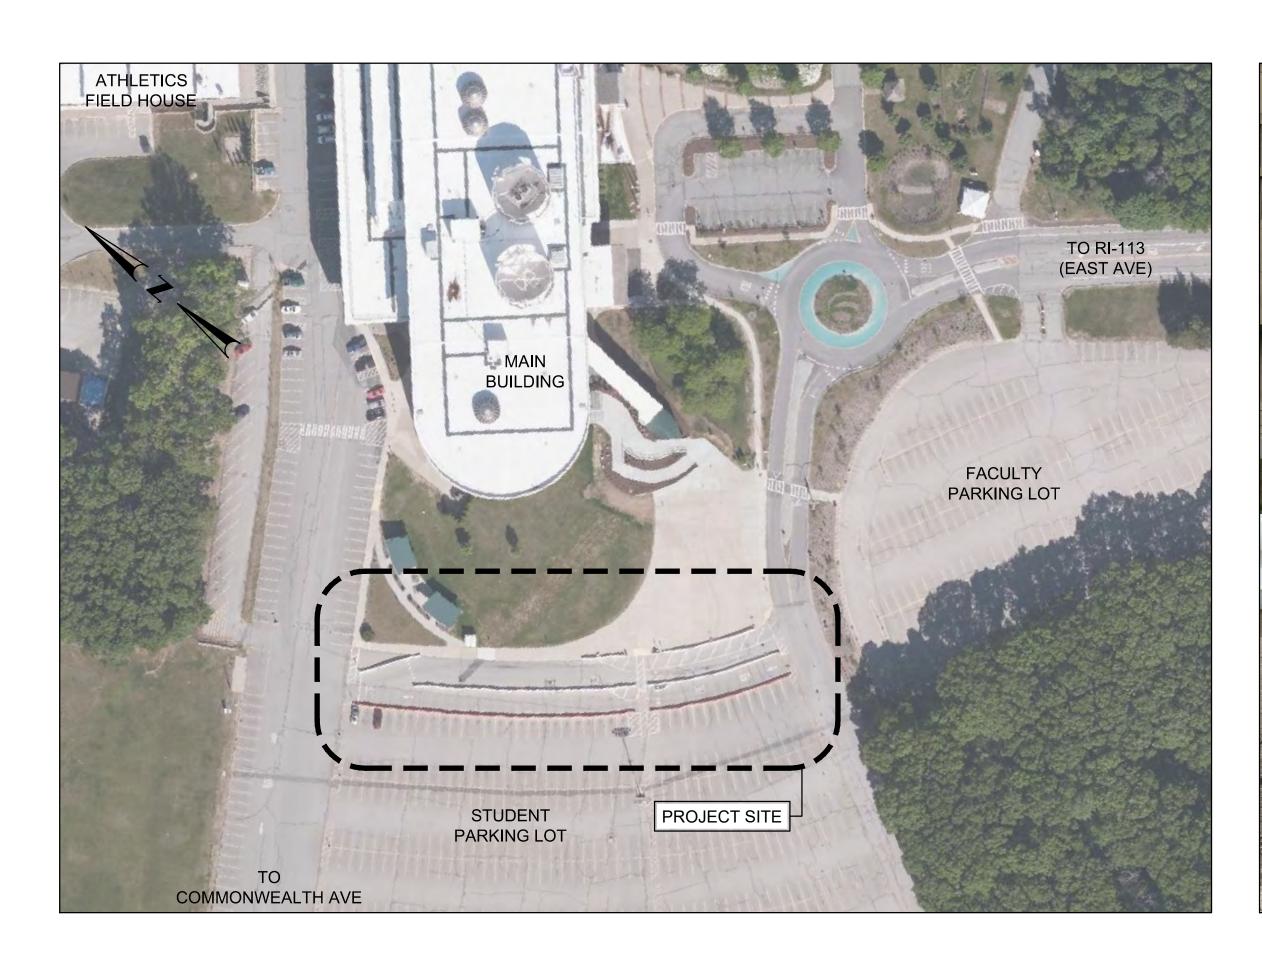





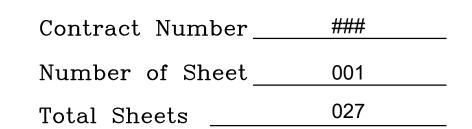

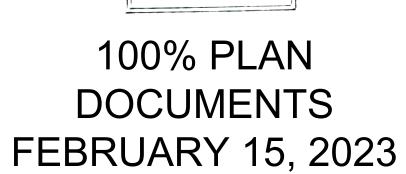

DAVID B. FREEMAN

<u>REFERENCES:</u>

- 1. PLANS ENTITLED "KNIGHT CAMPUS, CCRI RENEWAL-PHASE 1, 400 EAST AVENUE, WARWICK, R.I., PREPARED BY BREWSTER THORNTON GROUP AND PARE CORPORATION, DATED 10/20/2014.
- 2. PLANS ENTITLED "TRAFFIC SAFETY UPGRADES CCRI KNIGHT CAMPUS ENTRY RENEWAL, 400 EAST AVENUE, WARWICK, R.I., PREPARED BY BREWSTER THORNTON GROUP AND PARE CORPORATION, DATED 3/15/2017.
- 3. THE EXISTING CONDITIONS PLAN PREPARED FOR THIS DESIGN IS BASED ON A DATA ACCUMULATION SURVEY PERFORMED IN MARCH 2022; REVISED NOVEMBER 2022 BY MICHAEL BAKER INTERNATIONAL.
- 4. HORZONTAL AND VERTICAL CONTROL DATUMS ARE BASED ON SURVEY CONTROL INFORMATION REFERENCED FROM THE ABOVE NOTED PLANS.

GENERAL NOTES:

- THE STATE OF RHODE ISLAND STANDARD SPECIFICATIONS FOR ROAD AND BRIDGE CONSTRUCTION, 2004 EDITION AMENDED MARCH 2018, AND THE RHODE ISLAND STANDARD DETAILS ARE MADE A PART HEREOF AS FULLY AND COMPLETELY AS IF ATTACHED HERETO. ALL WORK SHALL CONFORM TO RHODE ISLAND STANDARD SPECIFICATIONS FOR ROAD AND BRIDGE CONSTRUCTION AND THE CONTRACT SPECIFICATIONS.
- THE CONTRACTOR SHALL MAKE ALL NECESSARY CONSTRUCTION NOTIFICATIONS AND APPLY FOR AND OBTAIN ALL NECESSARY CONSTRUCTION PERMITS, PAY ALL FEES AND POST ALL BONDS ASSOCIATED WITH THE SAME, AND COORDINATE WITH THE ENGINEER AND ARCHITECT AS REQUIRED.
- 3. THE CONTRACTOR SHALL BE SOLELY RESPONSIBLE FOR JOB SITE SAFETY. THE CONTRACTOR SHALL PROVIDE TEMPORARY FENCING AND/OR BARRIERS AROUND ALL OPEN EXCAVATED AREAS IN ACCORDANCE WITH OSHA STANDARDS.
- 4. IF ANY DEVIATION OR ALTERATION OF THE WORK PROPOSED ON THESE DRAWINGS IS REQUIRED, THE CONTRACTOR IS TO IMMEDIATELY CONTACT AND COORDINATE WITH THE ENGINEER AND OWNER.
- 5. ANY AREA OUTSIDE OF THE LIMIT OF WORK THAT IS DISTURBED SHALL BE RESTORED TO ITS ORIGINAL CONDITION AT NO COST TO THE OWNER.
- 6. ALL SITE WORK SHALL MEET OR EXCEED THE SITE WORK SPECIFICATIONS PREPARED FOR THIS PROJECT. THE CONTRACTOR SHALL BE RESPONSIBLE FOR VERIFYING THAT THE PROPOSED IMPROVEMENTS SHOWN ON THE PLANS DO NOT CONFLICT WITH ANY KNOWN EXISTING OR OTHER PROPOSED IMPROVEMENTS. IF ANY CONFLICTS ARE DISCOVERED, THE CONTRACTOR SHALL NOTIFY THE OWNER AND THE ENGINEER PRIOR TO INSTALLATION OF ANY PORTION OF THE SITE WORK WHICH WOULD
- 7. EXCAVATED ROCK SHALL BE REMOVED FROM THE SITE AND LEGALLY DISPOSED OF.
- 8. THE CONTRACTOR SHALL BE LIABLE FOR ALL DAMAGE AND/OR DISTURBANCES TO ADJACENT PROPERTY BEYOND THE LIMIT OF WORK. ACTUAL DAMAGE TO THESE AREAS, CAUSED BY THE CONTRACTOR, SHALL BE REPAIRED TO THE SATISFACTION OF THE OWNER'S REPRESENTATIVE AT NO ADDITIONAL COST TO RIPTA OR CCRI.
- 9. THE CONTRACTOR SHALL BE LIABLE FOR ALL DAMAGE AND/OR DISTURBANCE TO EXISTING TREES AND SHRUBS NOT OTHERWISE DESIGNATED FOR REMOVAL.
- 10. PLANTS DESIGNATED TO REMAIN SHALL BE PROTECTED BY THE PLACEMENT OF A TREE PROTECTION FENCE ENCLOSURE AROUND SHRUBS, OR AT THE DRIP LINE OF EACH TREE. PLACE TREE PROTECTION ADDITIONALLY AT ALL OTHER LOCATIONS WHERE TREES AND/OR SHRUBS MAY BE JEOPARDIZED BY CONSTRUCTION ACTIVITIES.
- 11. ALL EXISTING TREES TO REMAIN SHALL BE PROTECTED IN ACCORDANCE WITH DETAILS AS SHOWN.

<u>DEMOLITION NOTES:</u>

- 1. THE CONTRACTOR SHALL COORDINATE ALL DEMOLITION OF STRUCTURES, PAVEMENT AND CONCRETE MATERIALS, AND UTILITIES WITH APPROPRIATE PROPOSED DRAWINGS.
- 2. ALL NOTED UTILITIES TO BE REMOVED AND DISPOSED OF, RELOCATED OR CAPPED REPRESENT ALL KNOWN SITE CONDITIONS TO BE DEMOLISHED. CONTRACTOR TO COORDINATE ALL UNFORESEEN CONDITIONS WITH THE PROJECT ENGINEER AND/OR RESPECTIVE UTILITY COMPANIES PRIOR TO PROCEEDING WITH WORK
- 3. THERE SHALL BE NO INTERRUPTION OF UTILITY SERVICE DURING THE CONSTRUCTION OPERATION WITHOUT THE APPROVAL OF
- 4. WATER, SEWER, DRAINAGE AND OTHER SITE UTILITIES SERVICING THE EXISTING FACILITIES ARE TO REMAIN ACTIVE UNTIL PROPOSED IMPROVEMENTS ARE CONSTRUCTED AND ONLINE. WHEN CONNECTING TO ACTIVE OR RELOCATED UTILITIES, SHUTDOWNS SHALL BE MINIMIZED AND COMPLETED OFF HOURS AND COORDINATED WITH THE OWNER.

CONSTRUCTION NOTES:

- COORDINATION OF MAINTAINING TRAFFIC AND EROSION CONTROL MEASURES ARE THE RESPONSIBILITY OF THE CONTRACTOR. PRIOR TO ANY WORK, THE CONTRACTOR SHALL SUBMIT A TRAFFIC PLAN TO RIPTA AND CCRI FOR REVIEW AND APPROVAL.
- 2. CONTRACTOR TO COORDINATE PEDESTRIAN ACCESS DURING CONSTRUCTION WITH RIPTA AND CCRI.

GRADING AND UTILITY NOTES:

- 1. UNDERGROUND UTILITIES EXIST WITHIN THE PROJECT LIMITS. BEFORE COMMENCING ANY SITE WORK ACTIVITIES CONTACT "DIG SAFE" AT 1-888-DIG-SAFE AND MARK LIBUTTI. CCRI KNIGHT CAMPUS COLLEGE PROJECT MANAGER AT (401) 825-2380 TO ASSIST IN THE LOCATION OF UNDERGROUND UTILITIES. CONTRACTOR SHALL PROVIDE AN UNDERGROUND UTILITY LOCATOR TO MARK THE LOCATION OF ALL EXISTING UTILITIES WITHIN THE LIMIT OF DISTURBANCE PRIOR TO COMMENCING WORK. CONTRACTOR SHALL PROVIDE A PLAN IN AUTOCAD FORMAT PREPARED BY A LAND SURVEYOR REGISTERED IN THE STATE OF RHODE ISLAND DEPICTING ALL EXISTING UTILITIES AND MARKINGS PROVIDED BY THE UNDERGROUND UTILITY LOCATOR IN RELATION TO PERMANENT SITE FEATURES.
- 2. CONTRACTOR SHALL COORDINATE LOCATION OF ALL UTILITIES (LINES, DUCTS, CONDUITS, SLEEVES, FOOTINGS, ETC.) WITH LOCATIONS OF PROPOSED LANDSCAPE ELEMENTS (TREE ROOTBALLS, PROPOSED CURBING OR LIGHTING FOOTINGS, ETC.). CONTRACTOR SHALL REPORT ANY DISCREPANCIES TO THE OWNER'S REPRESENTATIVE PRIOR TO CONTINUING WORK. EXCAVATION REQUIRED WITHIN PROXIMITY OF UTILITY LINES OR WITHIN DRIPLINES OF EXISTING TREES TO REMAIN SHALL BE DONE BY HAND. ANY DAMAGE AND INCURRED COSTS DUE TO FAILURE OF THE CONTRACTOR TO CONTACT THE PROPER AUTHORITIES SHALL BE BOURNE BY THE CONTRACTOR.
- 2. ANY DAMAGE TO EXISTING UTILITIES OR STRUCTURES AS SHOWN ON THE PLANS SHALL BE THE CONTRACTOR'S RESPONSIBILITY. COSTS OF SUCH DAMAGE SHALL BE THE CONTRACTOR'S RESPONSIBILITY. NO EXCAVATION SHALL BE DONE UNTIL COMPANIES ARE PROPERLY NOTIFIED IN ADVANCE. NOTE THAT NOT ALL EXISTING UNDERGROUND UTILITIES ARE SHOWN. IT IS THE CONTRACTOR'S RESPONSIBILITY TO CONTACT ALL RESPECTIVE UTILITY COMPANIES TO VERIFY AND LOCATE
- 8. ALL WORK PERFORMED AND ALL MATERIALS FURNISHED SHALL CONFORM WITH THE LINES AND GRADES ON THE PLANS AND SITE WORK SPECIFICATIONS.
- 9. AT ALL LOCATIONS WHERE EXISTING CURBING OR PAVEMENT ABUT NEW CONSTRUCTION, THE EDGE OF THE EXISTING CURB OR PAVEMENT SHALL BE SAW CUT TO A CLEAN, SMOOTH EDGE. BLEND NEW PAVEMENT AND CURBS SMOOTHLY INTO EXISTING BY MATCHING LINES, GRADES AND JOINTS.
- 10. ALL UTILITY COVERS, GRATES, ETC. SHALL BE ADJUSTED TO BE FLUSH WITH THE SURROUNDING SURFACE OR PAVEMENT FINISH GRADE. RIM ELEVATIONS OF STRUCTURES AND MANHOLES ARE APPROXIMATE.
- 11. ALL DRAINAGE PIPES SHALL BE 12" CLASS III REINFORCED CONCRETE PIPE EXCEPT WHERE NOTED OTHERWISE.
- 12. WHERE AN EXISTING UTILITY IS FOUND TO CONFLICT WITH THE PROPOSED WORK, THE LOCATION, ELEVATION AND SIZE OF THE UTILITY SHALL BE ACCURATELY DETERMINED WITHOUT DELAY BY THE CONTRACTOR AND THE INFORMATION FURNISHED TO THE ENGINEER FOR RESOLUTION.
- 13. THE CONTRACTOR SHALL PROTECT ALL UNDERGROUND TEL/DATA DUCT BANKS, ELECTRICAL DUCT BANKS, DRAINAGE, SEWER AND UTILITY FACILITIES FROM EXCESSIVE VEHICULAR LOADS DURING CONSTRUCTION. ANY DAMAGE TO THESE FACILITIES RESULTING FROM CONSTRUCTION LOADS WILL BE RESTORED TO ORIGINAL CONDITION BY THE CONTRACTOR AT NO ADDITIONAL EXPENSE TO THE OWNER. DURING CONSTRUCTION OPERATIONS, THE CONTRACTOR SHALL PROTECT EXISTING UTILITIES BY PROVIDING TEMPORARY SUPPORTS OR SHEETING AS REQUIRED AT NO ADDITIONAL COST TO THE OWNER.
- 14. RITCH EVENLY BETWEEN SPOT GRADES. ALL PAVED AREAS MUST PITCH TO DRAIN AT A MINIMUM OF 1/8" PER FOOT UNLESS SPECIFIED.
- 15. THE PROPOSED WALKWAYS SHALL HAVE A MAXIMUM CROSS SLOPE OF 2% AND RUNNING SLOPE OF 5% AS SHOWN ON CONSTRUCTION DETAILS AND GRADING PLAN.
- 16. ALL GRADING AT ACCESSIBLE ROUTES SHALL COMPLY WITH THE RULES AND REGULATIONS OF THE AMERICANS WITH DISABILITIES ACT (ADA) OF 2010, LATEST EDITION.
- 17. THE CONTRACTOR IS RESPONSIBLE FOR REMOVAL AND DISPOSAL OF ALL ROCK AND BOULDERS UNCOVERED DURING UTILITY INSTALLATION. REFER TO EARTHWORK SPECIFICATION.

STORMWATER MANAGEMENT SYSTEM INSPECTION AND MAINTENANCE NOTES:

- 1. THE CONTRACTOR IS RESPONSIBLE FOR ALL EQUIPMENT, MATERIAL, AND LABOR REQUIRED TO CLEAN OUT EXISTING CATCH BASINS AND DRAINAGE LINES PRIOR TO COMMENCING WORK. ALL DEBRIS REMOVED SHALL BECOME THE PROPERTY OF THE CONTRACTOR AND LEGALLY DISPOSED.
- 2. THE CONTRACTOR SHALL INSPECT ALL DRAINAGE STRUCTURES WEEKLY FOR ACCUMULATION OF TRASH, LITTER, SEDIMENT OR DEBRIS AND CLEAN STRUCTURES IF PRESENT.
- 3. THE CONTRACTOR SHALL REMOVE TRASH, LITTER, SEDIMENT AND DEBRIS FROM ALL CATCH BASINS, MANHOLES, WATER QUALITY STRUCTURES ON A ROUTINE BASIS, IMMEDIATELY FOLLOWING SITE STABILIZATION AND PRIOR TO PROJECT COMPLETION AND ACCEPTANCE.
- 4. ANY ACCUMULATION OF PONDING WATER IN AREAS WITHIN THE LIMITS OF DISTURBANCE, OTHER THAN DESIGNATED AREAS, SHALL BE REMOVED ACCORDINGLY AND PREVENTED IN THE FUTURE.
- 5. THE PORTION OF THE STUDENT PARKING LOT AFFECTED BY CONSTRUCTION AND ENTRY DRIVES SHALL BE SWEPT BY THE CONTRACTOR PRIOR TO PROJECT COMPLETION AND ACCEPTANCE.
- 6. ALL DRAINAGE STRUCTURES SHALL BE CLEARED OF ACCUMULATED SEDIMENT PRIOR TO ACCEPTANCE OF THE FINAL PROJECT.

MATERIALS NOTES:

- 1. PROVIDE EXPANSION JOINTS IN CONCRETE WALK AT 20'-0" ON CENTER AND CONTROL JOINTS AT MINIMUM 5'-0" ON CENTER AS PER SPECIFICATIONS UNLESS OTHERWISE NOTED ON PLANS.
- 2. CONTRACTOR TO INSTALL EXPANSION JOINTS WHERE CONCRETE MEETS A VERTICAL SURFACE SUCH AS BUILDING WALLS, RETAINING WALLS, CURBS, FOOTINGS, AND EXISTING PAVEMENT.

LAYOUT NOTES:

- 1. CONTRACTOR SHALL CONTRACT WITH A RHODE ISLAND REGISTERED LAND SURVEYOR TO PROVIDE CONSTRUCTION LAYOUT, AND TO PERFORM BENCHMARK FIELD LEVEL VERIFICATION AND COORDINATE LAYOUT CHECK PRIOR TO CONSTRUCTION. CONTRACTOR TO CONTACT THE ENGINEER IF ANY DISCREPANCIES ARE FOUND.
- 2. ALL LINES ARE PERPENDICULAR OR PARALLEL TO THE LINES FROM WHICH THEY ARE MEASURED UNLESS OTHERWISE INDICATED.
- 3. ALL DIMENSIONS FOR LIGHTS, BENCHES, AND TRASH RECEPTACLES ARE TO THE CENTERLINE OF THE OBJECT UNLESS OTHERWISE NOTED.
- 4. DIMENSIONS TO SITE OR BUILDING WALLS ARE TO THE OUTSIDE (OR EXPOSED) FACE OF WALL UNLESS OTHERWISE NOTED.

EROSION AND SEDIMENTATION CONTROL NOTES:

- 1. THE CONTRACTOR SHALL COMPLY WITH ALL CONDITIONS OF THE RIPDES GENERAL PERMIT AND ALL OTHER PERMITS OBTAINED FOR THIS PROJECT. CONTRACTOR SHALL COMPLETE ALL RESPONSIBILITIES ASSOCIATED WITH THE SOIL EROSION AND SEDIMENT CONTROL PLAN PREPARED FOR THIS PROJECT.
- 2. CONTRACTOR SHALL BE RESPONSIBLE FOR ESTABLISHING AND MAINTAINING ALL TEMPORARY SEDIMENT AND EROSION CONTROLS IN ACCORDANCE WITH THE RHODE ISLAND EROSION AND SEDIMENT CONTROL HANDBOOK 2014 REVISION (AS
- 3. THE EROSION AND SEDIMENTATION CONTROLS SHOWN ON THE PLANS ARE INTENDED TO REPRESENT THE MINIMUM CONTROLS NECESSARY TO MEET ANTICIPATED SITE CONDITIONS. ADDITIONAL MEASURES SHALL BE IMPLEMENTED AS CONDITIONS WARRANT OR AS DIRECTED BY THE OWNER OR OWNER'S REPRESENTATIVE.
- 4. REQUIRED PERMANENT CONTROL SHALL BE PROPERLY ESTABLISHED, CLEARLY VISIBLE AND IN OPERATION PRIOR TO INITIATING ANY LAND CLEARING ACTIVITY AND/OR OTHER CONSTRUCTION RELATED WORK. SUCH FACILITIES SHALL REPRESENT THE LIMIT OF WORK. WORKERS SHALL BE INFORMED THAT NO CONSTRUCTION ACTIVITY IS TO OCCUR BEYOND THE LIMIT OF WORK AT ANY TIME THROUGHOUT THE CONSTRUCTION PERIOD.
- 5. CONSTRUCTION WILL BE PHASED TO LIMIT THE AREA OF EXPOSED SOIL AND THE DURATION OF EXPOSURE. ALL DISTURBED AREAS WILL BE TEMPORARILY AND/OR PERMANENTLY STABILIZED WITHIN 14 DAYS FOLLOWING COMPLETION OF GRADING
- 6. THE CONTRACTOR SHALL INSPECT AND MAINTAIN ALL EROSION AND SEDIMENTATION CONTROL MEASURES AS SPECIFIED IN THE GENERAL PERMIT AND SWPPP THROUGHOUT THE CONSTRUCTION PERIOD.
- 7. EROSION AND SEDIMENTATION CONTROL MEASURES SHALL BE INSPECTED AUD MAINTAINED ON A WEEKLY BASIS AND AFTER EACH STORM EVENT OF 0.25 INCH OR GREATER DURING CONSTRUCTION TO ENSURE THAT CHANNELS, DITCHES AND PIPES ARE CLEAR OF DEBRIS AND THAT THE EROSION CONTROL BARRIERS ARE INTACT.
- 8. CLEAN AND MAINTAIN SEDIMENTATION CONTROL BARRIERS WHEN SEDIMENT ACCUMULATES TO ONE HALF THE HEIGHT OF THE BARRIER. MATÉRIAL COLLECTED FROM THE SEDIMENTATION BARRIER SHALL BE REMOVED AS NECESSARY AND DISPOSED IN AND UPLAND AREA.
- 9. WEEKLY INSPECTION LOGS SHALL BE PREPARED BY THE CONTRACTOR AND SUBMITTED TO THE PROJECT ENGINEER.
- 10. THE CONTRACTOR SHALL MAINTAIN A SUFFICIENT RESERVE OF VARIOUS EROSION CONTROL MATERIALS ONSITE AT ALL TIMES FOR EMERGENCY PURPOSES OR ROUTINE MAINTENANCE.
- 11. THE CONTRACTOR SHALL SCHEDULE HIS WORK TO ALLOW THE FINISHED SUBGRADE ELEVATIONS TO DRAIN PROPERLY WITHOUT PUDDLING. SPECIFICALLY, ALLOW WATER TO ESCAPE WHERE PROPOSED CURB MAY RETAIN RUNOFF PRIOR TO PAVING. PROVIDE TEMPORARY POSITIVE DRAINAGE, AS REQUIRED, TO STABILIZED DISCHARGE POINTS.
- 12. SOIL AND OTHER MATERIALS RESULTING FROM SITE CLEARING MAY BE RECYCLED AND/OR REUSED ON THE SITE AS APPROPRIATE. WASTES MATERIALS SHALL BE REMOVED FROM THE SITE.
- 13. ANTI-TRACKING PADS (RIDOT STD. 9.9.0) SHALL BE ESTABLISHED AT ALL POINTS OF INGRESS AND EGRESS.
- 14. TEMPORARY DIVERSION (TD) MAY CONSIST OF A DITCH OR SWALE, OR MAY BE ACHIEVED USING WOOD CHIP PILES, COIR LOGS, OR SIMILAR MATERIALS.
- 15. TEMPORARY SEDIMENT BASINS (TSB) AND TEMPORARY SWALES (TS) SHALL BE SIZED BY THE CONTRACTOR USING THE PARAMETERS CONTAINED IN THE RHODE ISLAND SOIL EROSION AND SEDIMENT CONTROL MANUAL.
- 16. TEMPORARY DIVERSIONS UTILIZED DURING ROADWAY CONSTRUCTION (TDC) MAY CONSIST OF SHALLOW DITCHES OR BARRIERS CONSISTING OF COIR LOGS OR LOW EARTH BERMS.
- 17. DUST SHALL BE CONTROLLED BY SPRINKLING OR OTHER APPROVED METHODS AS NECESSARY, OR AS DIRECTED BY THE OWNER OR OWNER'S REPRESENTATIVE.
- 18. CATCH BASINS AND STORM DRAINS SHALL BE PROTECTED WITH COMPOST FILTER TUBES (CFT) OR SEDIMENT BAGS IN PAVED

AREAS UNTIL CONTRIBUTING AREA IS PERMANENTLY STABILIZED.

- 19. DEWATERING WASTEWATER PUMPED FROM EXCAVATIONS WILL BE CONVEYED BY HOSE TO AN UPLAND AREA AND DISCHARGED INTO A DEWATERING BASIN (RIDOT STD 9.7.0), HAY BALE CORRALS, OR SEDIMENTATION BAGS. THE CONTRACTOR SHALL TEST THE DEWATERING WASTEWATER FOR CONTAMINANTS PRIOR TO DISCHARGING. THE CONTRACTOR IS RESPONSIBLE FOR ALL
- ENGINEERING, EQUIPMENT, MATERIAL, AND LABOR REQUIRED FOR THIS PROJECT PROPOSED SITE WATER REMOVAL DURING CONSTRUCTION. 20. CONSTRUCTION SITE WASTE MATERIALS WILL BE PROPERLY CONTAINED ONSITE AND DISPOSED OFF SITE AT A LOCATION IN
- ACCORDANCE WITH THE LOCAL AND STATE REGULATIONS. 21. RIPRAP OR OTHER VELOCITY CONTROL DEVICES WILL BE USED WHERE NECESSARY TO CONTROL EROSION.
- 22. ANY EQUIPMENT THAT IS NOT READILY MOBILE (TRACK MACHINERY) SHALL BE PARKED WITHIN THE PROJECT LIMIT OF DISTURBANCE. LARGE AND/OR BULKY MATERIALS WILL BE STORED SUCH THAT THEY WILL NOT INTERFERE WITH THE ONGOING CONSTRUCTION ACTIVITY AND EROSION CONTROL MEASURES.
- 23. NEWLY VEGETATED AREAS SHALL BE REGULARLY INSPECTED AND MAINTAINED TO ENSURE THE ESTABLISHMENT OF STABLE **VEGETATED SURFACES.**
- 24. THE CONTRACTOR SHALL NOT REMOVE ANY EROSION CONTROLS UNTIL THE CONTRIBUTING AREA IS PERMANENTLY STABILIZED.

Providence, RI 02903

(401) 824-3600

REFERENCES:

- 1. PLANS ENTITLED "KNIGHT CAMPUS, CCRI RENEWAL-PHASE 1, 400 EAST AVENUE, WARWICK, R.I., PREPARED BY BREWSTER THORNTON GROUP AND PARE CORPORATION, DATED 10/20/2014.
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GENERAL NOTES:

- 1. THE STATE OF RHODE ISLAND STANDARD SPECIFICATIONS FOR ROAD AND BRIDGE CONSTRUCTION, 2004 EDITION AMENDED MARCH 2018, AND THE RHODE ISLAND STANDARD DETAILS ARE MADE A PART HEREOF AS FULLY AND COMPLETELY AS IF ATTACHED HERETO. ALL WORK SHALL CONFORM TO RHODE ISLAND STANDARD SPECIFICATIONS FOR ROAD AND BRIDGE CONSTRUCTION AND THE CONTRACT SPECIFICATIONS.
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- 7. EXCAVATED ROCK, UNSUITABLE EXCAVATED MATERIALS, AND EXCESS MATERIAL SHALL BE REMOVED FROM THE SITE AND LEGALLY DISPOSED OF.
- 8. THE CONTRACTOR SHALL BE LIABLE FOR ALL DAMAGE AND/OR DISTURBANCES TO ADJACENT PROPERTY BEYOND THE LIMIT OF WORK. ACTUAL DAMAGE TO THESE AREAS, CAUSED BY THE CONTRACTOR, SHALL BE REPAIRED TO THE SATISFACTION OF THE OWNER'S REPRESENTATIVE AT NO ADDITIONAL COST TO RIPTA OR CCRI.
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GRADING AND UTILITY NOTES:

- 1. UNDERGROUND UTILITIES EXIST WITHIN THE PROJECT LIMITS. BEFORE COMMENCING ANY SITE WORK ACTIVITIES CONTACT "DIG SAFE" AT 1-888-DIG-SAFE AND MARK LIBUTTI, CCRI KNIGHT CAMPUS COLLEGE PROJECT MANAGER AT (401) 825-2380 TO ASSIST IN THE LOCATION OF UNDERGROUND UTILITIES. CONTRACTOR SHALL PROVIDE AN UNDERGROUND UTILITY LOCATOR TO MARK THE LOCATION OF ALL EXISTING UTILITIES WITHIN THE LIMIT OF DISTURBANCE PRIOR TO COMMENCING WORK. CONTRACTOR SHALL PROVIDE A PLAN IN AUTOCAD FORMAT PREPARED BY A LAND SURVEYOR REGISTERED IN THE STATE OF RHODE ISLAND DEPICTING ALL EXISTING UTILITIES AND MARKINGS PROVIDED BY THE UNDERGROUND UTILITY LOCATOR IN RELATION TO PERMANENT SITE FEATURES.
- 2. CONTRACTOR SHALL COORDINATE LOCATION OF ALL UTILITIES (LINES, DUCTS, CONDUITS, SLEEVES, FOOTINGS, ETC.) WITH LOCATIONS OF PROPOSED LANDSCAPE ELEMENTS (TREE ROOTBALLS, PROPOSED CURBING OR LIGHTING FOOTINGS, ETC.). CONTRACTOR SHALL REPORT ANY DISCREPANCIES TO THE OWNER'S REPRESENTATIVE PRIOR TO CONTINUING WORK. EXCAVATION REQUIRED WITHIN PROXIMITY OF UTILITY LINES OR WITHIN DRIPLINES OF EXISTING TREES TO REMAIN SHALL BE DONE BY HAND. ANY DAMAGE AND INCURRED COSTS DUE TO FAILURE OF THE CONTRACTOR TO CONTACT THE PROPER AUTHORITIES SHALL BE BOURNE BY THE CONTRACTOR.
- 3. ANY DAMAGE TO EXISTING UTILITIES OR STRUCTURES SHALL BE THE CONTRACTOR'S RESPONSIBILITY. COSTS OF SUCH DAMAGE SHALL BE THE CONTRACTOR'S RESPONSIBILITY. NO EXCAVATION SHALL BE DONE UNTIL COMPANIES AND CCRI ARE PROPERLY NOTIFIED IN ADVANCE. NOTE THAT NOT ALL EXISTING UNDERGROUND UTILITIES ARE SHOWN ON THE PLANS. IT IS THE CONTRACTOR'S RESPONSIBILITY TO CONTACT ALL RESPECTIVE UTILITY COMPANIES AND CCRI TO VERIFY AND LOCATE EXISTING UTILITIES.
 - I. ALL WORK PERFORMED AND ALL MATERIALS FURNISHED SHALL CONFORM WITH THE LINES AND GRADES ON THE PLANS AND SITE WORK SPECIFICATIONS.
 - 5. AT ALL LOCATIONS WHERE EXISTING CURBING OR PAVEMENT ABUT NEW CONSTRUCTION, THE EDGE OF THE EXISTING CURB
 OR PAVEMENT SHALL BE SAW CUT TO A CLEAN, SMOOTH EDGE. BLEND NEW PAVEMENT AND CURBS SMOOTHLY INTO
 EXISTING BY MATCHING LINES, GRADES AND JOINTS.
 - 6. ALL UTILITY COVERS, GRATES, ETC. SHALL BE ADJUSTED TO BE FLUSH WITH THE SURROUNDING SURFACE OR PAVEMENT FINISH GRADE. RIM ELEVATIONS OF STRUCTURES AND MANHOLES ARE APPROXIMATE.
 - $\left<7\right>$ ALL DRAINAGE PIPES SHALL BE 12" CLASS III REINFORCED CONCRETE PIPE EXCEPT WHERE NOTED OTHERWISE.
 - 8. WHERE AN EXISTING UTILITY IS FOUND TO CONFLICT WITH THE PROPOSED WORK, THE LOCATION, ELEVATION AND SIZE OF
 THE UTILITY SHALL BE ACCURATELY DETERMINED WITHOUT DELAY BY THE CONTRACTOR AND THE INFORMATION FURNISHED
 TO THE ENGINEER FOR RESOLUTION.
 - THE CONTRACTOR SHALL PROTECT ALL UNDERGROUND TEL/DATA DUCT BANKS, ELECTRICAL DUCT BANKS, DRAINAGE, SEWER

 AND UTILITY FACILITIES FROM EXCESSIVE VEHICULAR LOADS DURING CONSTRUCTION. ANY DAMAGE TO THESE FACILITIES

 RESULTING FROM CONSTRUCTION LOADS WILL BE RESTORED TO ORIGINAL CONDITION BY THE CONTRACTOR AT NO

 ADDITIONAL EXPENSE TO THE OWNER. DURING CONSTRUCTION OPERATIONS, THE CONTRACTOR SHALL PROTECT EXISTING

 UTILITIES BY PROVIDING TEMPORARY SUPPORTS OR SHEETING AS REQUIRED AT NO ADDITIONAL COST TO THE OWNER.
 - 10. PITCH EVENLY BETWEEN SPOT GRADES. ALL PAVED AREAS MUST PITCH TO DRAIN AT A MINIMUM OF 1/8" PER FOOT UNLESS SPECIFIED.
 - (11. A 1.75% TYPICAL CROSS-SLOPE HAS BEEN USED FOR PROPOSED WALKWAYS. FINAL CONSTRUCTED WALKWAYS SHALL NOT EXCEED A MAXIMUM CROSS SLOPE OF 2.00% AND RUNNING SLOPE OF 5.00%.

- 12. ALL GRADING AT ACCESSIBLE ROUTES SHALL COMPLY WITH THE RULES AND REGULATIONS OF THE AMERICANS WITH DISABILITIES ACT (ADA) OF 2010, LATEST EDITION.
- 13. THE CONTRACTOR IS RESPONSIBLE FOR REMOVAL AND DISPOSAL OF ALL ROCK AND BOULDERS UNCOVERED DURING UTILITY INSTALLATION. REFER TO EARTHWORK SPECIFICATION.

STORMWATER MANAGEMENT SYSTEM INSPECTION AND MAINTENANCE NOTES:

- 1. THE CONTRACTOR IS RESPONSIBLE FOR ALL EQUIPMENT, MATERIAL, AND LABOR REQUIRED TO CLEAN OUT EXISTING CATCH BASINS AND DRAINAGE LINES PRIOR TO COMMENCING WORK. ALL DEBRIS REMOVED SHALL BECOME THE PROPERTY OF THE CONTRACTOR AND LEGALLY DISPOSED.
- $\left\{2.\right\}$ THE CONTRACTOR SHALL INSPECT ALL DRAINAGE STRUCTURES WEEKLY AND AFTER STORM EVENTS FOR ACCUMULATION OF TRASH, LITTER, SEDIMENT OR DEBRIS AND CLEAN STRUCTURES IF PRESENT.
- 3. THE CONTRACTOR SHALL REMOVE TRASH, LITTER, SEDIMENT AND DEBRIS FROM ALL CATCH BASINS, MANHOLES, WATER QUALITY STRUCTURES ON A ROUTINE BASIS OR AS NEEDED, IMMEDIATELY FOLLOWING SITE STABILIZATION AND PRIOR TO PROJECT COMPLETION AND ACCEPTANCE.
- 4. ANY ACCUMULATION OF PONDING WATER IN AREAS WITHIN THE LIMITS OF DISTURBANCE, OTHER THAN DESIGNATED AREAS, SHALL BE REMOVED ACCORDINGLY AND PREVENTED IN THE FUTURE.
- 5. THE PORTION OF THE STUDENT PARKING LOT AFFECTED BY CONSTRUCTION AND ENTRY DRIVES SHALL BE SWEPT BY THE CONTRACTOR PRIOR TO PROJECT COMPLETION AND ACCEPTANCE.
- 6. ALL DRAINAGE STRUCTURES SHALL BE CLEARED OF ACCUMULATED SEDIMENT PRIOR TO ACCEPTANCE OF THE FINAL PROJECT.

MATERIALS NOTES:

- 1. PROVIDE EXPANSION JOINTS IN CONCRETE WALK AT 20'-0" ON CENTER AND CONTROL JOINTS AT MINIMUM 5'-0" ON CENTER AS PER SPECIFICATIONS UNLESS OTHERWISE NOTED ON PLANS.
- 2. CONTRACTOR TO INSTALL EXPANSION JOINTS WHERE CONCRETE MEETS A VERTICAL SURFACE SUCH AS BUILDING WALLS, RETAINING WALLS, CURBS, FOOTINGS, AND EXISTING PAVEMENT.

LAYOUT NOTES:

- 1. CONTRACTOR SHALL CONTRACT WITH A RHODE ISLAND REGISTERED LAND SURVEYOR TO PROVIDE CONSTRUCTION LAYOUT, AND TO PERFORM BENCHMARK FIELD LEVEL VERIFICATION AND COORDINATE LAYOUT CHECK PRIOR TO CONSTRUCTION. CONTRACTOR TO CONTACT THE ENGINEER IF ANY DISCREPANCIES ARE FOUND.
- 2. ALL LINES ARE PERPENDICULAR OR PARALLEL TO THE LINES FROM WHICH THEY ARE MEASURED UNLESS OTHERWISE INDICATED.
- 3. ALL DIMENSIONS FOR LIGHTS, BENCHES, AND TRASH RECEPTACLES ARE TO THE CENTERLINE OF THE OBJECT UNLESS OTHERWISE NOTED.
- 4. DIMENSIONS TO SITE OR BUILDING WALLS ARE TO THE OUTSIDE (OR EXPOSED) FACE OF WALL UNLESS OTHERWISE NOTED.

EROSION AND SEDIMENTATION CONTROL NOTES:

- {1. THE CONTRACTOR SHALL COMPLY WITH ALL CONDITIONS OF THE RIPDES GENERAL PERMIT. CONTRACTOR SHALL COMPLETE ALL RESPONSIBILITIES ASSOCIATED WITH THE SITE PREPARATION PLAN PREPARED FOR THIS PROJECT.
- 2. CONTRACTOR SHALL BE RESPONSIBLE FOR ESTABLISHING AND MAINTAINING ALL TEMPORARY SEDIMENT AND EROSION CONTROLS IN ACCORDANCE WITH THE RHODE ISLAND EROSION AND SEDIMENT CONTROL HANDBOOK 2014 REVISION (AS LIBRATED)
- 3. THE EROSION AND SEDIMENTATION CONTROLS SHOWN ON THE PLANS ARE INTENDED TO REPRESENT THE MINIMUM CONTROLS NECESSARY TO MEET ANTICIPATED SITE CONDITIONS. ADDITIONAL MEASURES SHALL BE IMPLEMENTED AS CONDITIONS WARRANT OR AS DIRECTED BY THE OWNER OR OWNER'S REPRESENTATIVE.
- 4. REQUIRED PERMANENT CONTROL SHALL BE PROPERLY ESTABLISHED, CLEARLY VISIBLE AND IN OPERATION PRIOR TO INITIATING ANY LAND CLEARING ACTIVITY AND/OR OTHER CONSTRUCTION RELATED WORK. SUCH FACILITIES SHALL REPRESENT THE LIMIT OF WORK. WORKERS SHALL BE INFORMED THAT NO CONSTRUCTION ACTIVITY IS TO OCCUR BEYOND THE LIMIT OF WORK AT ANY TIME THROUGHOUT THE CONSTRUCTION PERIOD.
- 5. CONSTRUCTION WILL BE PHASED TO LIMIT THE AREA OF EXPOSED SOIL AND THE DURATION OF EXPOSURE. ALL DISTURBED AREAS WILL BE TEMPORARILY AND/OR PERMANENTLY STABILIZED WITHIN 14 DAYS FOLLOWING COMPLETION OF GRADING ACTIVITIES.
- 6. THE CONTRACTOR SHALL INSPECT AND MAINTAIN ALL EROSION AND SEDIMENTATION CONTROL MEASURES AS SPECIFIED IN THE SITE PREPARATION PLAN THROUGHOUT THE CONSTRUCTION PERIOD.
 - 7. EROSION AND SEDIMENTATION CONTROL MEASURES SHALL BE INSPECTED AUD MAINTAINED ON A WEEKLY BASIS AND AFTER EACH STORM EVENT OF 0.25 INCH OR GREATER DURING CONSTRUCTION TO ENSURE THAT CHANNELS, DITCHES AND PIPES ARE CLEAR OF DEBRIS AND THAT THE EROSION CONTROL BARRIERS ARE INTACT.
 - 8. CLEAN AND MAINTAIN SEDIMENTATION CONTROL BARRIERS WHEN SEDIMENT ACCUMULATES TO ONE HALF THE HEIGHT OF THE BARRIER. MATERIAL COLLECTED FROM THE SEDIMENTATION BARRIER SHALL BE REMOVED AS NECESSARY AND DISPOSED IN AND UPLAND AREA.
 - 9. WEEKLY INSPECTION LOGS SHALL BE PREPARED BY THE CONTRACTOR AND SUBMITTED TO THE PROJECT ENGINEER.
 - 10. THE CONTRACTOR SHALL MAINTAIN A SUFFICIENT RESERVE OF VARIOUS EROSION CONTROL MATERIALS ONSITE AT ALL TIMES FOR EMERGENCY PURPOSES OR ROUTINE MAINTENANCE.
 - 11. THE CONTRACTOR SHALL SCHEDULE HIS WORK TO ALLOW THE FINISHED SUBGRADE ELEVATIONS TO DRAIN PROPERLY WITHOUT PUDDLING. SPECIFICALLY, ALLOW WATER TO ESCAPE WHERE PROPOSED CURB MAY RETAIN RUNOFF PRIOR TO PAVING. PROVIDE TEMPORARY POSITIVE DRAINAGE, AS REQUIRED, TO STABILIZED DISCHARGE POINTS.
 - 12. SOIL AND OTHER MATERIALS RESULTING FROM SITE CLEARING MAY BE RECYCLED AND/OR REUSED ON THE SITE AS APPROPRIATE. WASTES MATERIALS SHALL BE REMOVED FROM THE SITE.
 - 13. ANTI-TRACKING PADS (RIDOT STD. 9.9.0) SHALL BE ESTABLISHED AT ALL POINTS OF INGRESS AND EGRESS.
 - 14. TEMPORARY DIVERSION (TD) MAY CONSIST OF A DITCH OR SWALE, OR MAY BE ACHIEVED USING WOOD CHIP PILES, COIR LOGS, OR SIMILAR MATERIALS.
- 15. TEMPORARY SEDIMENT BASINS (TSB) AND TEMPORARY SWALES (TS) SHALL BE SIZED BY THE CONTRACTOR USING THE PARAMETERS CONTAINED IN THE RHODE ISLAND SOIL EROSION AND SEDIMENT CONTROL MANUAL.
- 16. TEMPORARY DIVERSIONS UTILIZED DURING ROADWAY CONSTRUCTION (TDC) MAY CONSIST OF SHALLOW DITCHES OR BARRIERS CONSISTING OF COIR LOGS OR LOW EARTH BERMS.
- 17. DUST SHALL BE CONTROLLED BY SPRINKLING OR OTHER APPROVED METHODS AS NECESSARY, OR AS DIRECTED BY THE
- OWNER OR OWNER'S REPRESENTATIVE.

 18. CATCH BASINS AND STORM DRAINS SHALL BE PROTECTED WITH SEDIMENT BAGS IN PAVED AREAS UNTIL CONTRIBUTING AREA
- IS PERMANENTLY STABILIZED. COMPOST FILTER TUBES (CFT) MAY BE ADDED BASED ON WORK, SITE CONDITIONS, AND
 WEATHER

 19 DEWATERING WASTEWATER BUMBED FROM EXCAVATIONS WILL BE CONVEYED BY HOSE TO AN LIPLAND AREA AND DISCHARGED
- 19. DEWATERING WASTEWATER PUMPED FROM EXCAVATIONS WILL BE CONVEYED BY HOSE TO AN UPLAND AREA AND DISCHARGED INTO A DEWATERING BASIN (RIDOT STD 9.7.0), HAY BALE CORRALS, OR SEDIMENTATION BAGS. THE CONTRACTOR SHALL TEST THE DEWATERING WASTEWATER FOR CONTAMINANTS PRIOR TO DISCHARGING. THE CONTRACTOR IS RESPONSIBLE FOR ALL ENGINEERING, EQUIPMENT, MATERIAL, AND LABOR REQUIRED FOR THIS PROJECT PROPOSED SITE WATER REMOVAL DURING CONSTRUCTION.
- 20. CONSTRUCTION SITE WASTE MATERIALS WILL BE PROPERLY CONTAINED ONSITE AND DISPOSED OFF SITE AT A LOCATION IN ACCORDANCE WITH THE LOCAL AND STATE REGULATIONS.
- 21. RIPRAP OR OTHER VELOCITY CONTROL DEVICES WILL BE USED WHERE NECESSARY TO CONTROL EROSION.
- 22. ANY EQUIPMENT THAT IS NOT READILY MOBILE (TRACK MACHINERY) SHALL BE PARKED WITHIN THE PROJECT LIMIT OF DISTURBANCE. LARGE AND/OR BULKY MATERIALS WILL BE STORED SUCH THAT THEY WILL NOT INTERFERE WITH THE ONGOING CONSTRUCTION ACTIVITY AND EROSION CONTROL MEASURES.
- 23. NEWLY VEGETATED AREAS SHALL BE REGULARLY INSPECTED AND MAINTAINED TO ENSURE THE ESTABLISHMENT OF STABLE VEGETATED SURFACES.
- 24. THE CONTRACTOR SHALL NOT REMOVE ANY EROSION CONTROLS UNTIL THE CONTRIBUTING AREA IS PERMANENTLY STABILIZED.


ADDENDUM NO. 03







DESIGNE	D BY: JC	SCAL	E: N/A					RIPTA-CCRI ENHANCED BU	JS
CHECKE	D BY: DF							WARWICK SERVICE PROJECT	RHODE ISLAND
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NOTES:

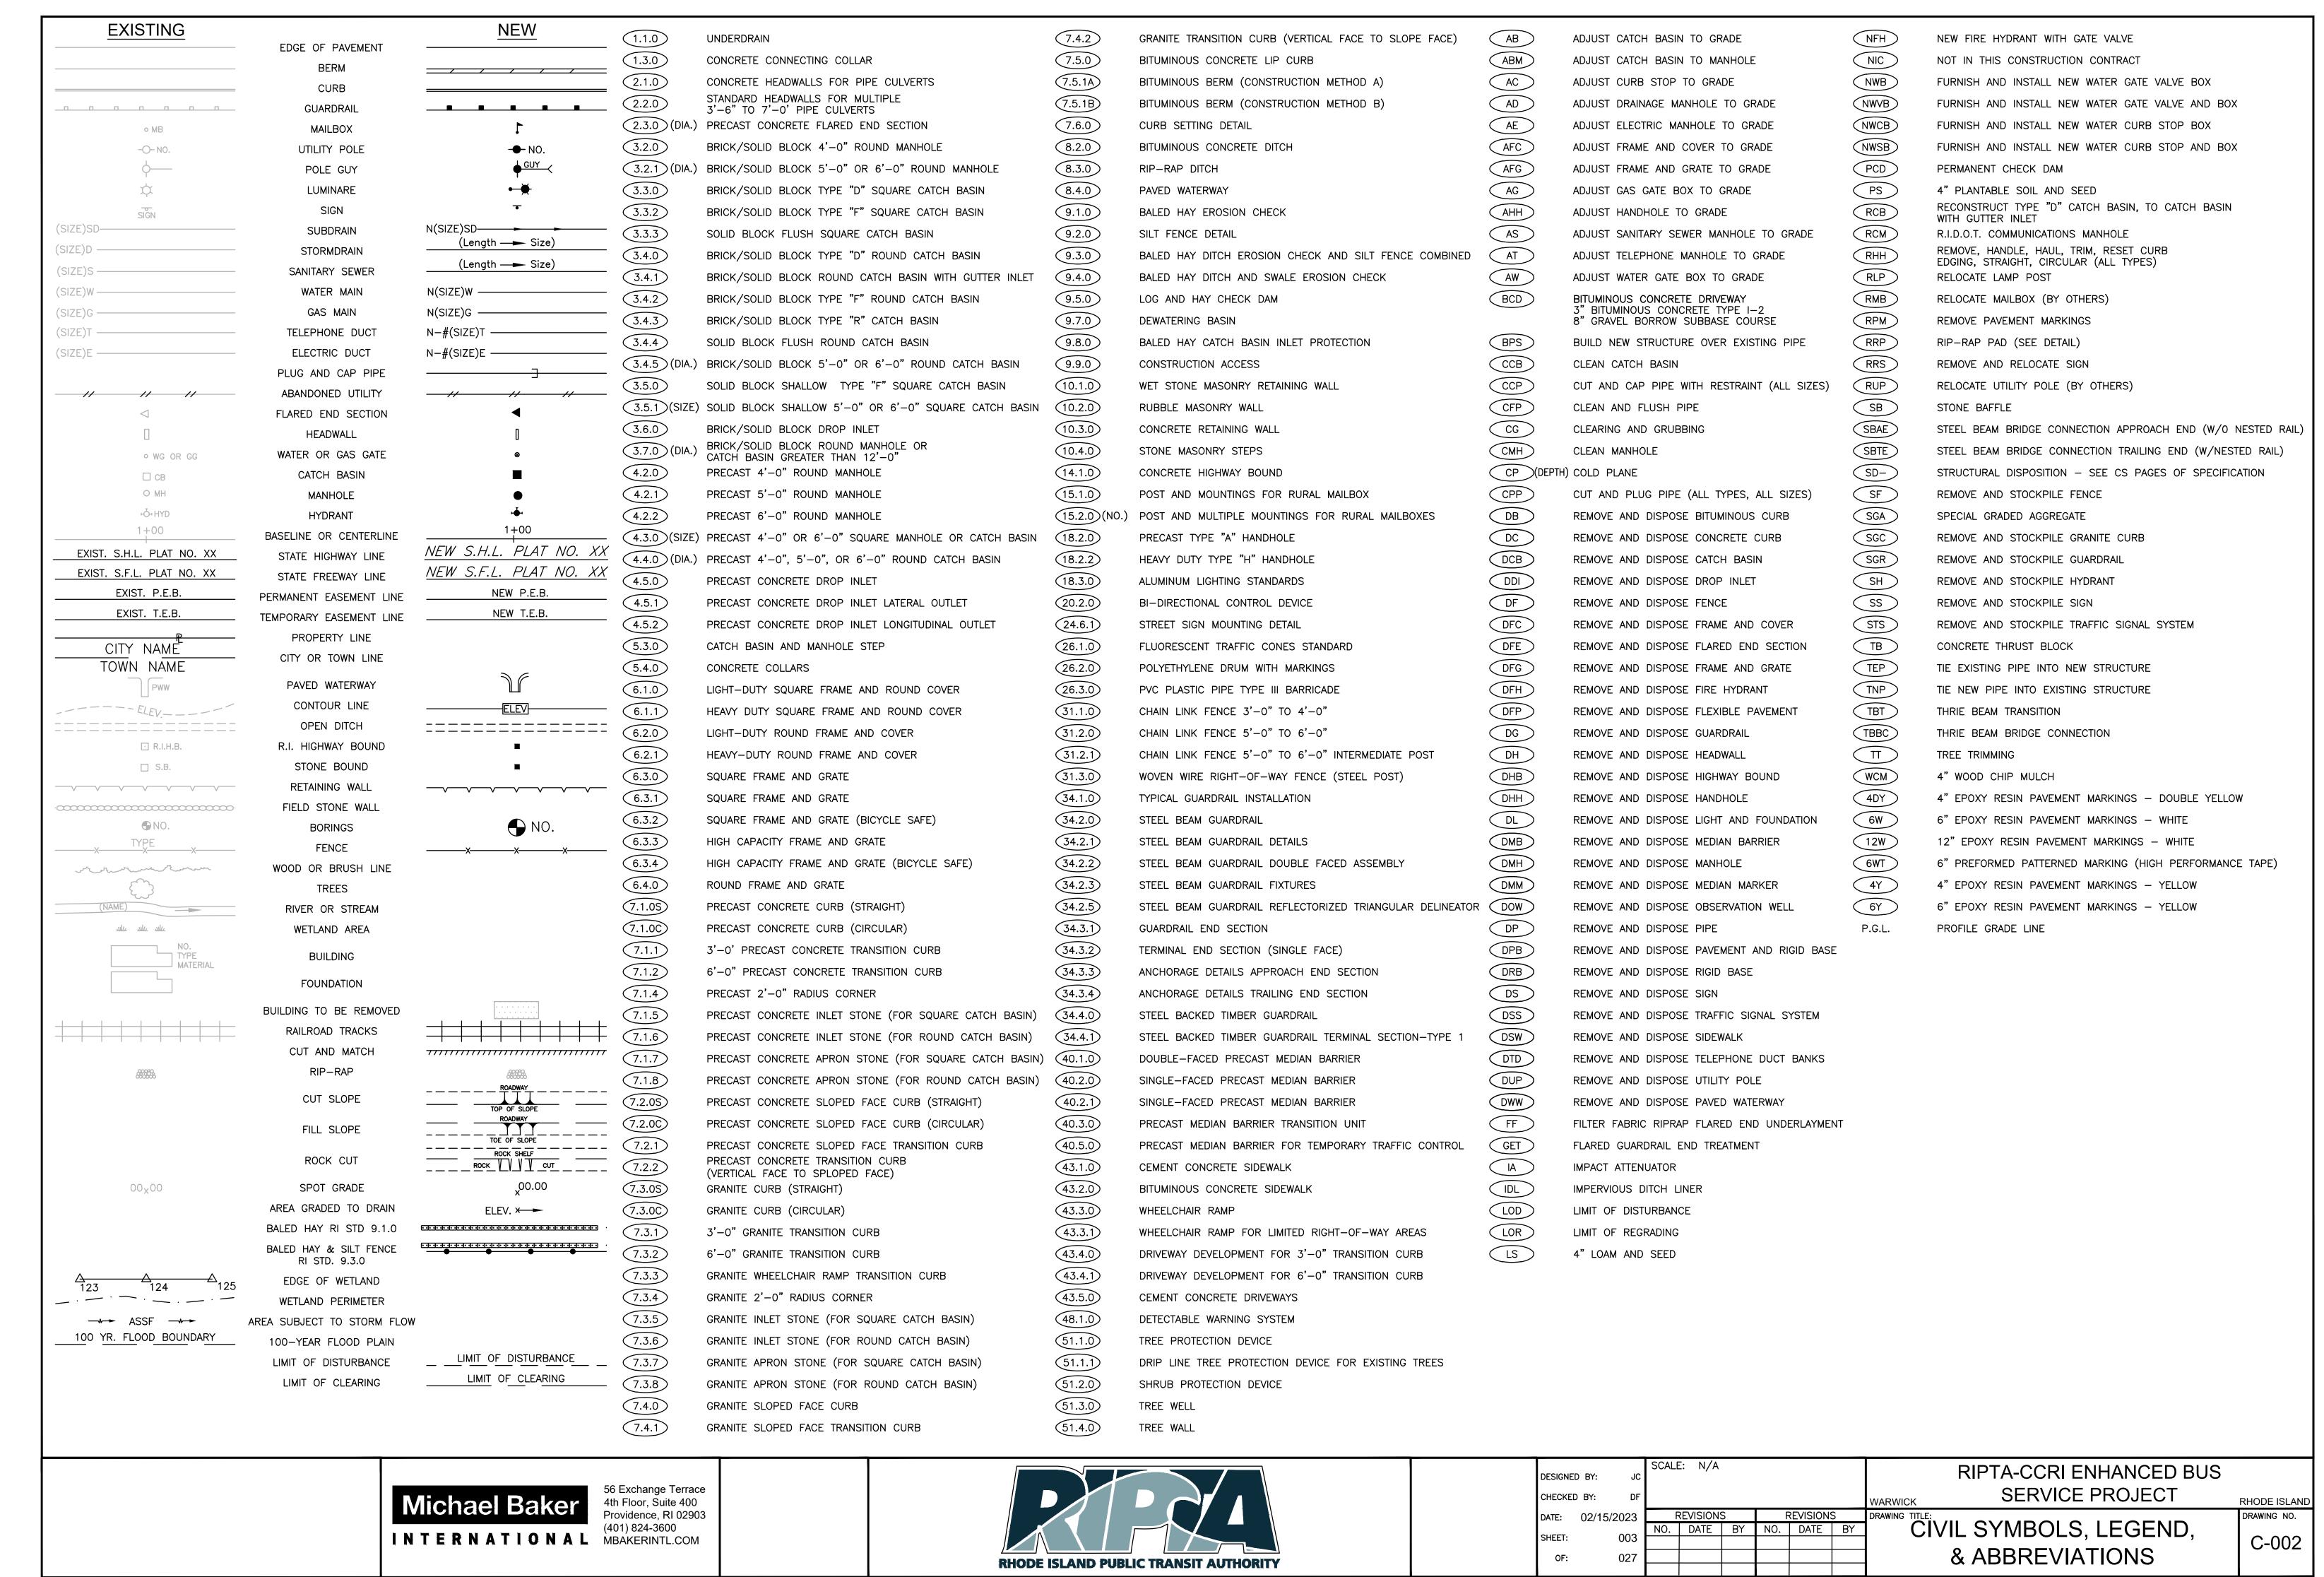1. PAVEMENT DETAILS:


"CONCRETE PAVEMENT" (12") PORTLAND CEMENT CONCRETE PAVEMENT OVER (12") GRAVEL BORROW SUBBASE (TYPE 1A)

"FULL DEPTH BITUMINOUS PAVEMENT"

(2") MODIFIED CLASS 9.5 HMA OVER

(4") CLASS 19.0 HMA OVER (12") GRAVEL BORROW SUBBASE (TYPE 1A)

2. REFER TO GRADING & DRAINAGE PLAN DRAWING C-111 FOR ADDITIONAL SLOPE AND SPOT ELEVATIONS AT BUS/TRAVEL LANE ENTRY AND EXIT INTERSECTIONS.

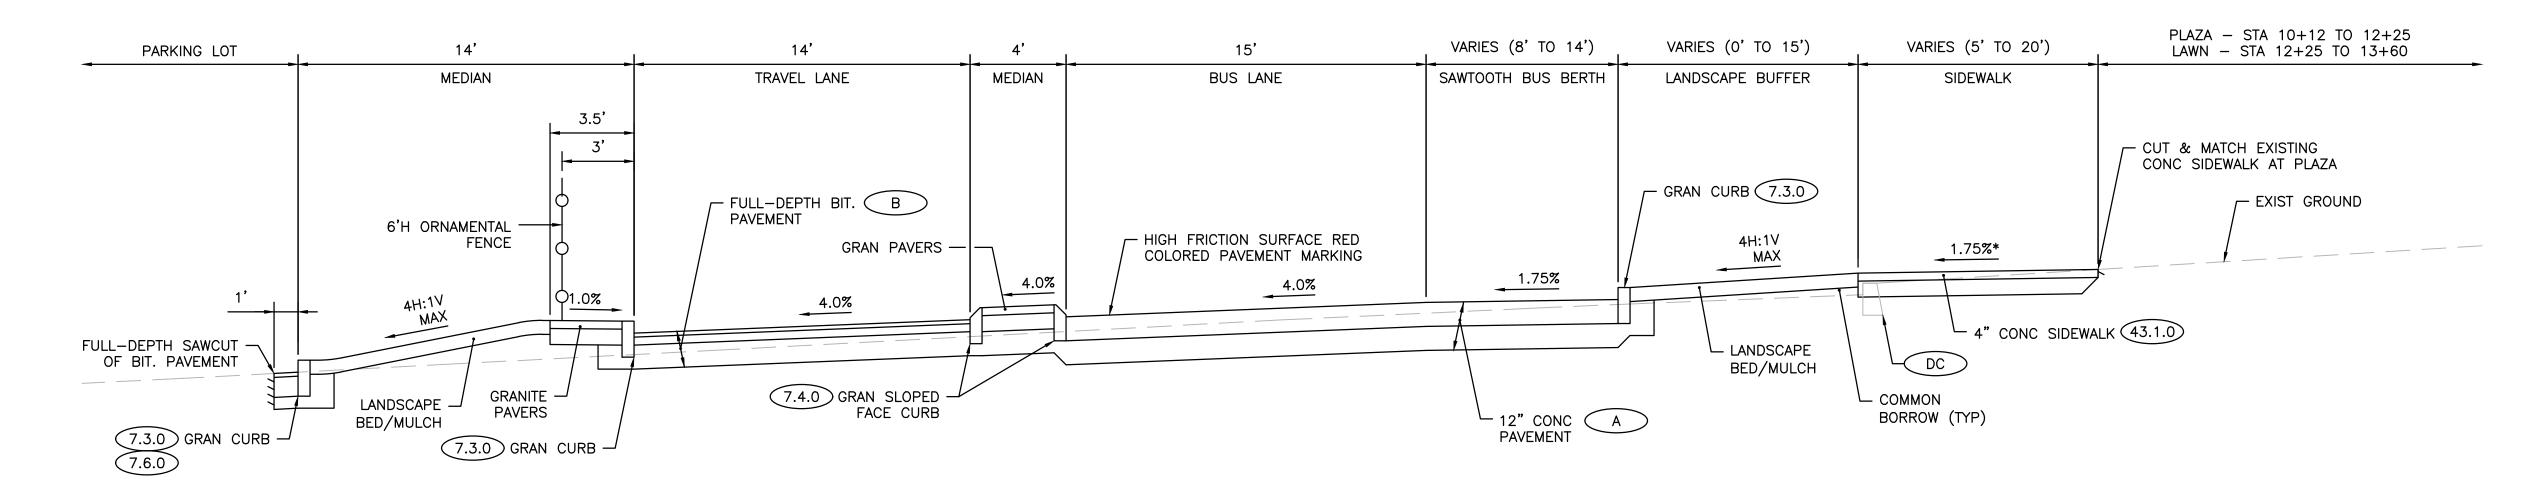

TYPICAL SECTION STA. 10+38± TO STA. 13+40±

56 Exchange Terrace 4th Floor, Suite 400 Providence, RI 02903 Michael Baker INTERNATIONAL MBAKERINTL.COM



			SCALE
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RHODE ISLAND DRAWING NO.

C-003


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Boring a	# P-1		Proi		-Mail: nebc@ PTA - CCRI	nebo	rıng.com	Project # 49587	
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-		0' – 2'					Auger Probe, n Very dense bro	o sampling. wn, fine to medium SAND and GRAVEL.	
-		2' – 5.6'					Medium dense	, brown, fine to medium SAND, some Grave	
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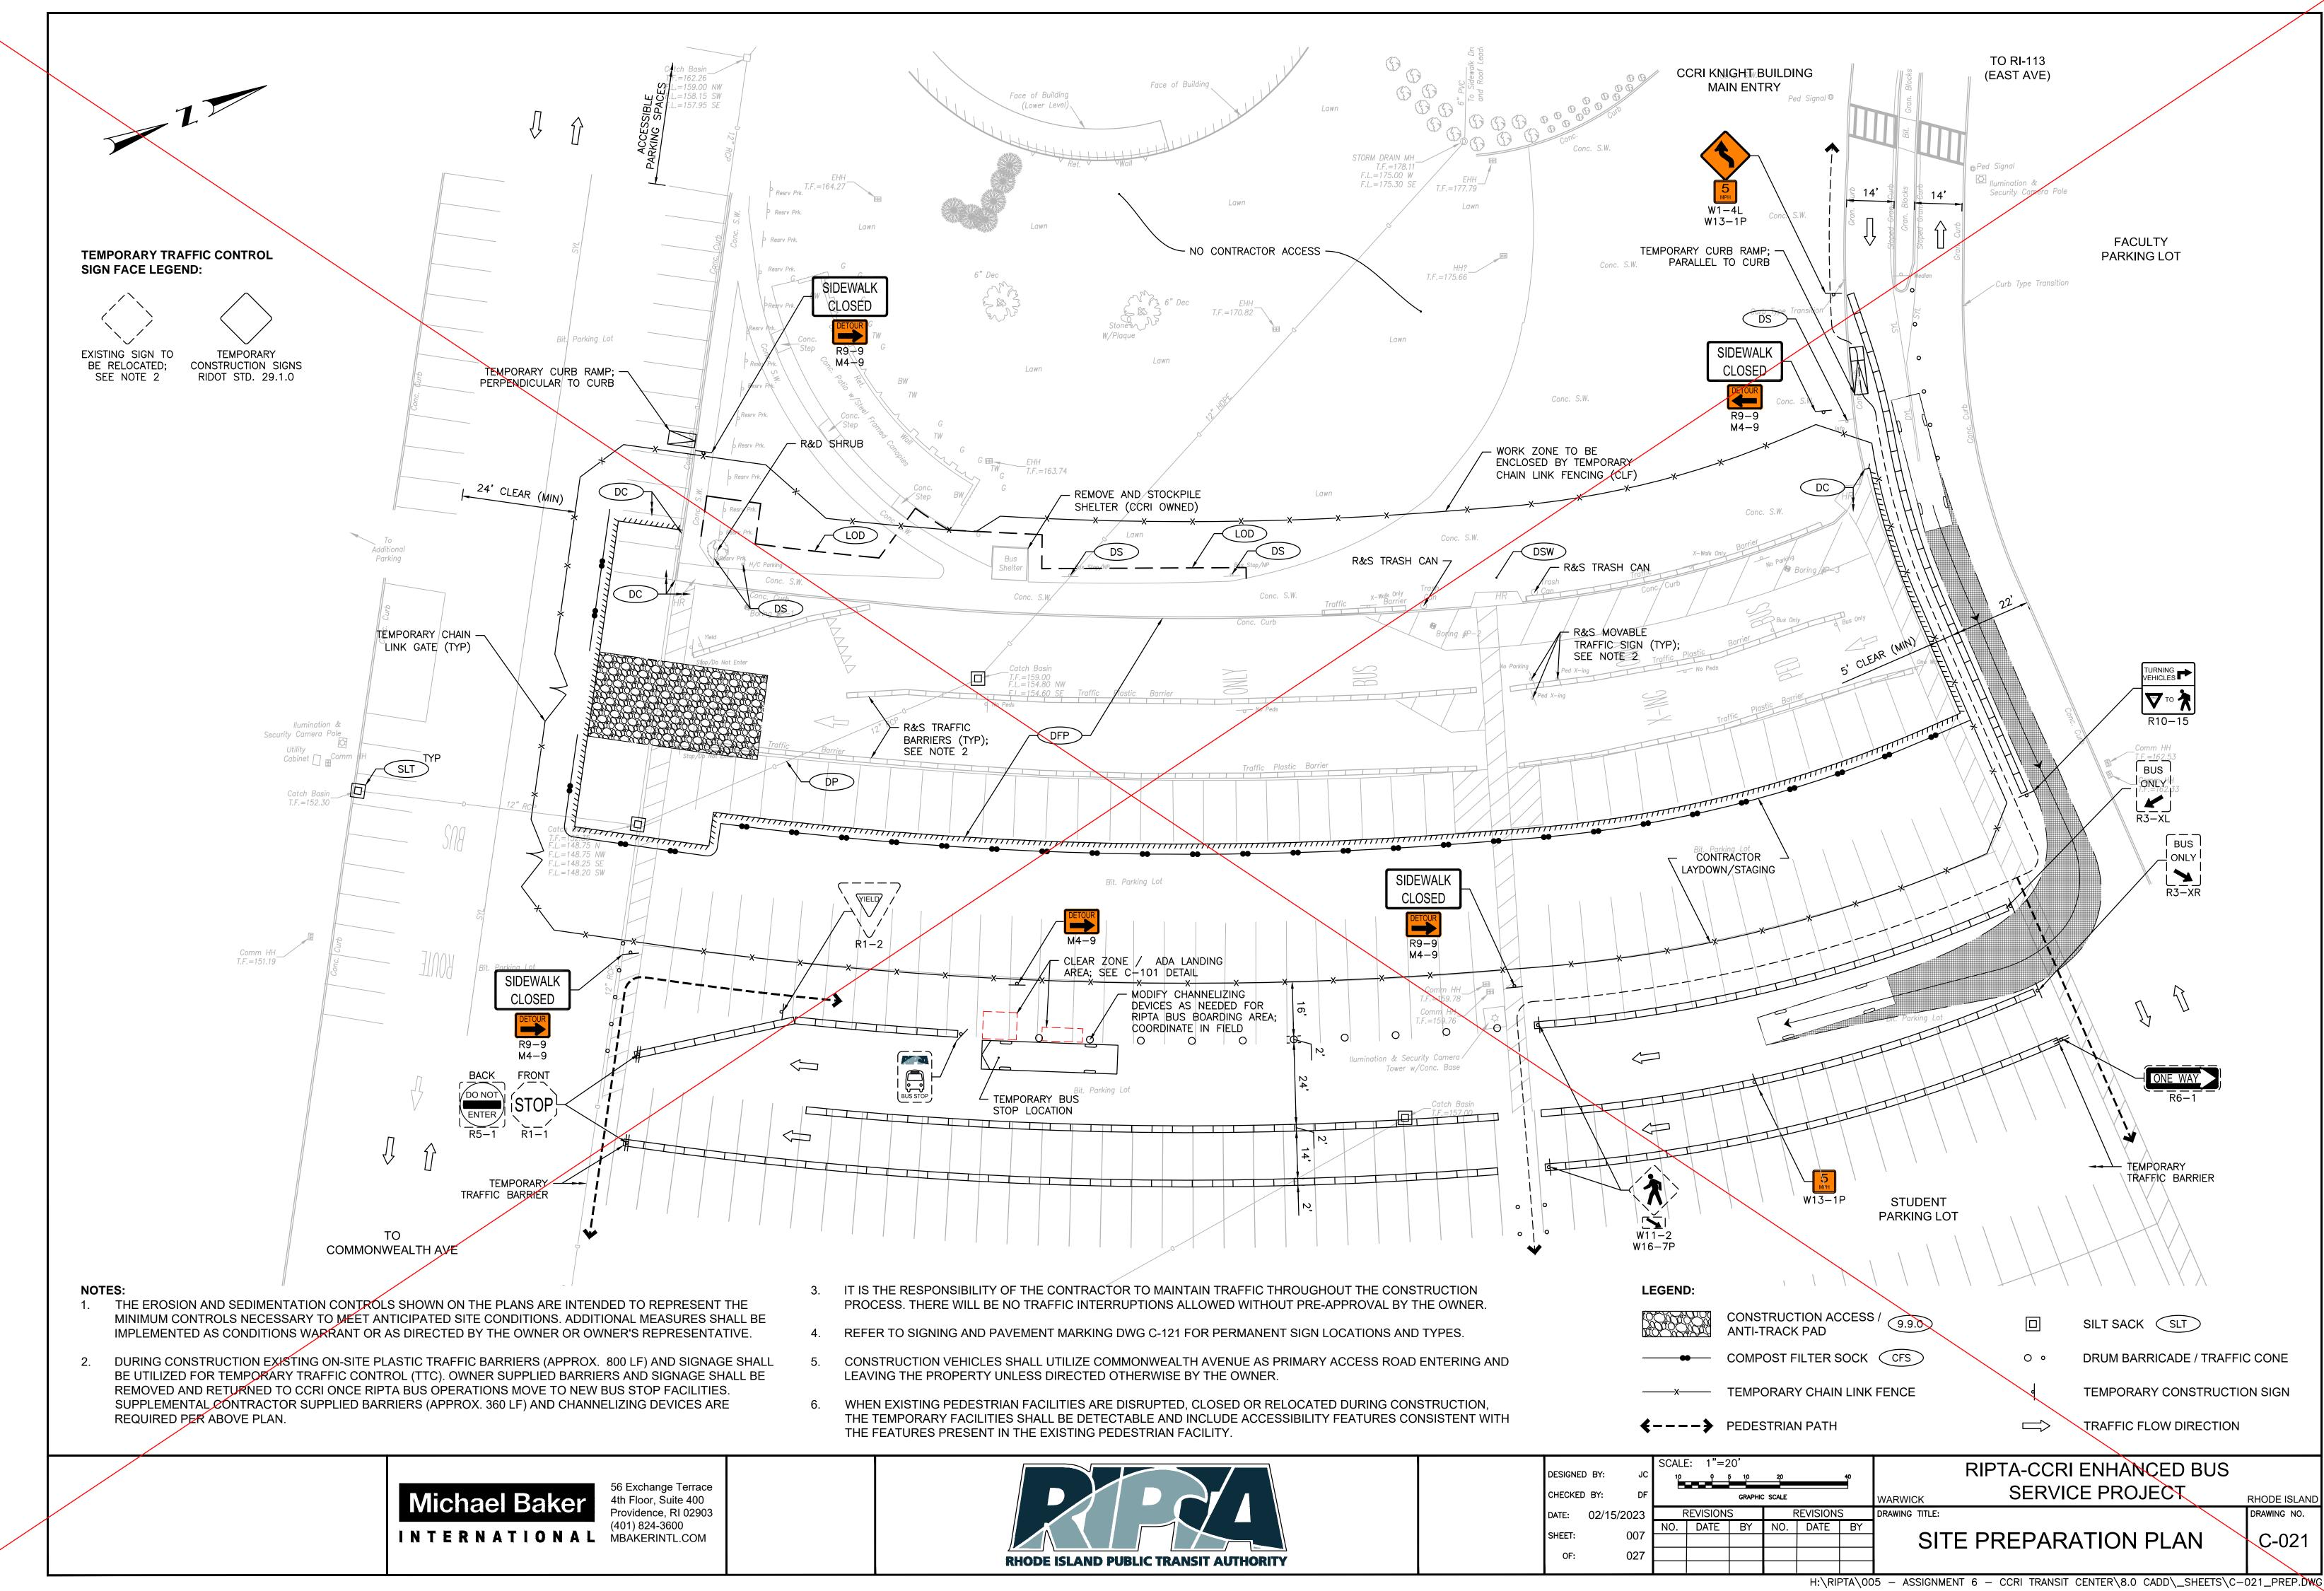
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Project	Addres	s: URI				City	: Warwick	State: RI	Zip: 02886	
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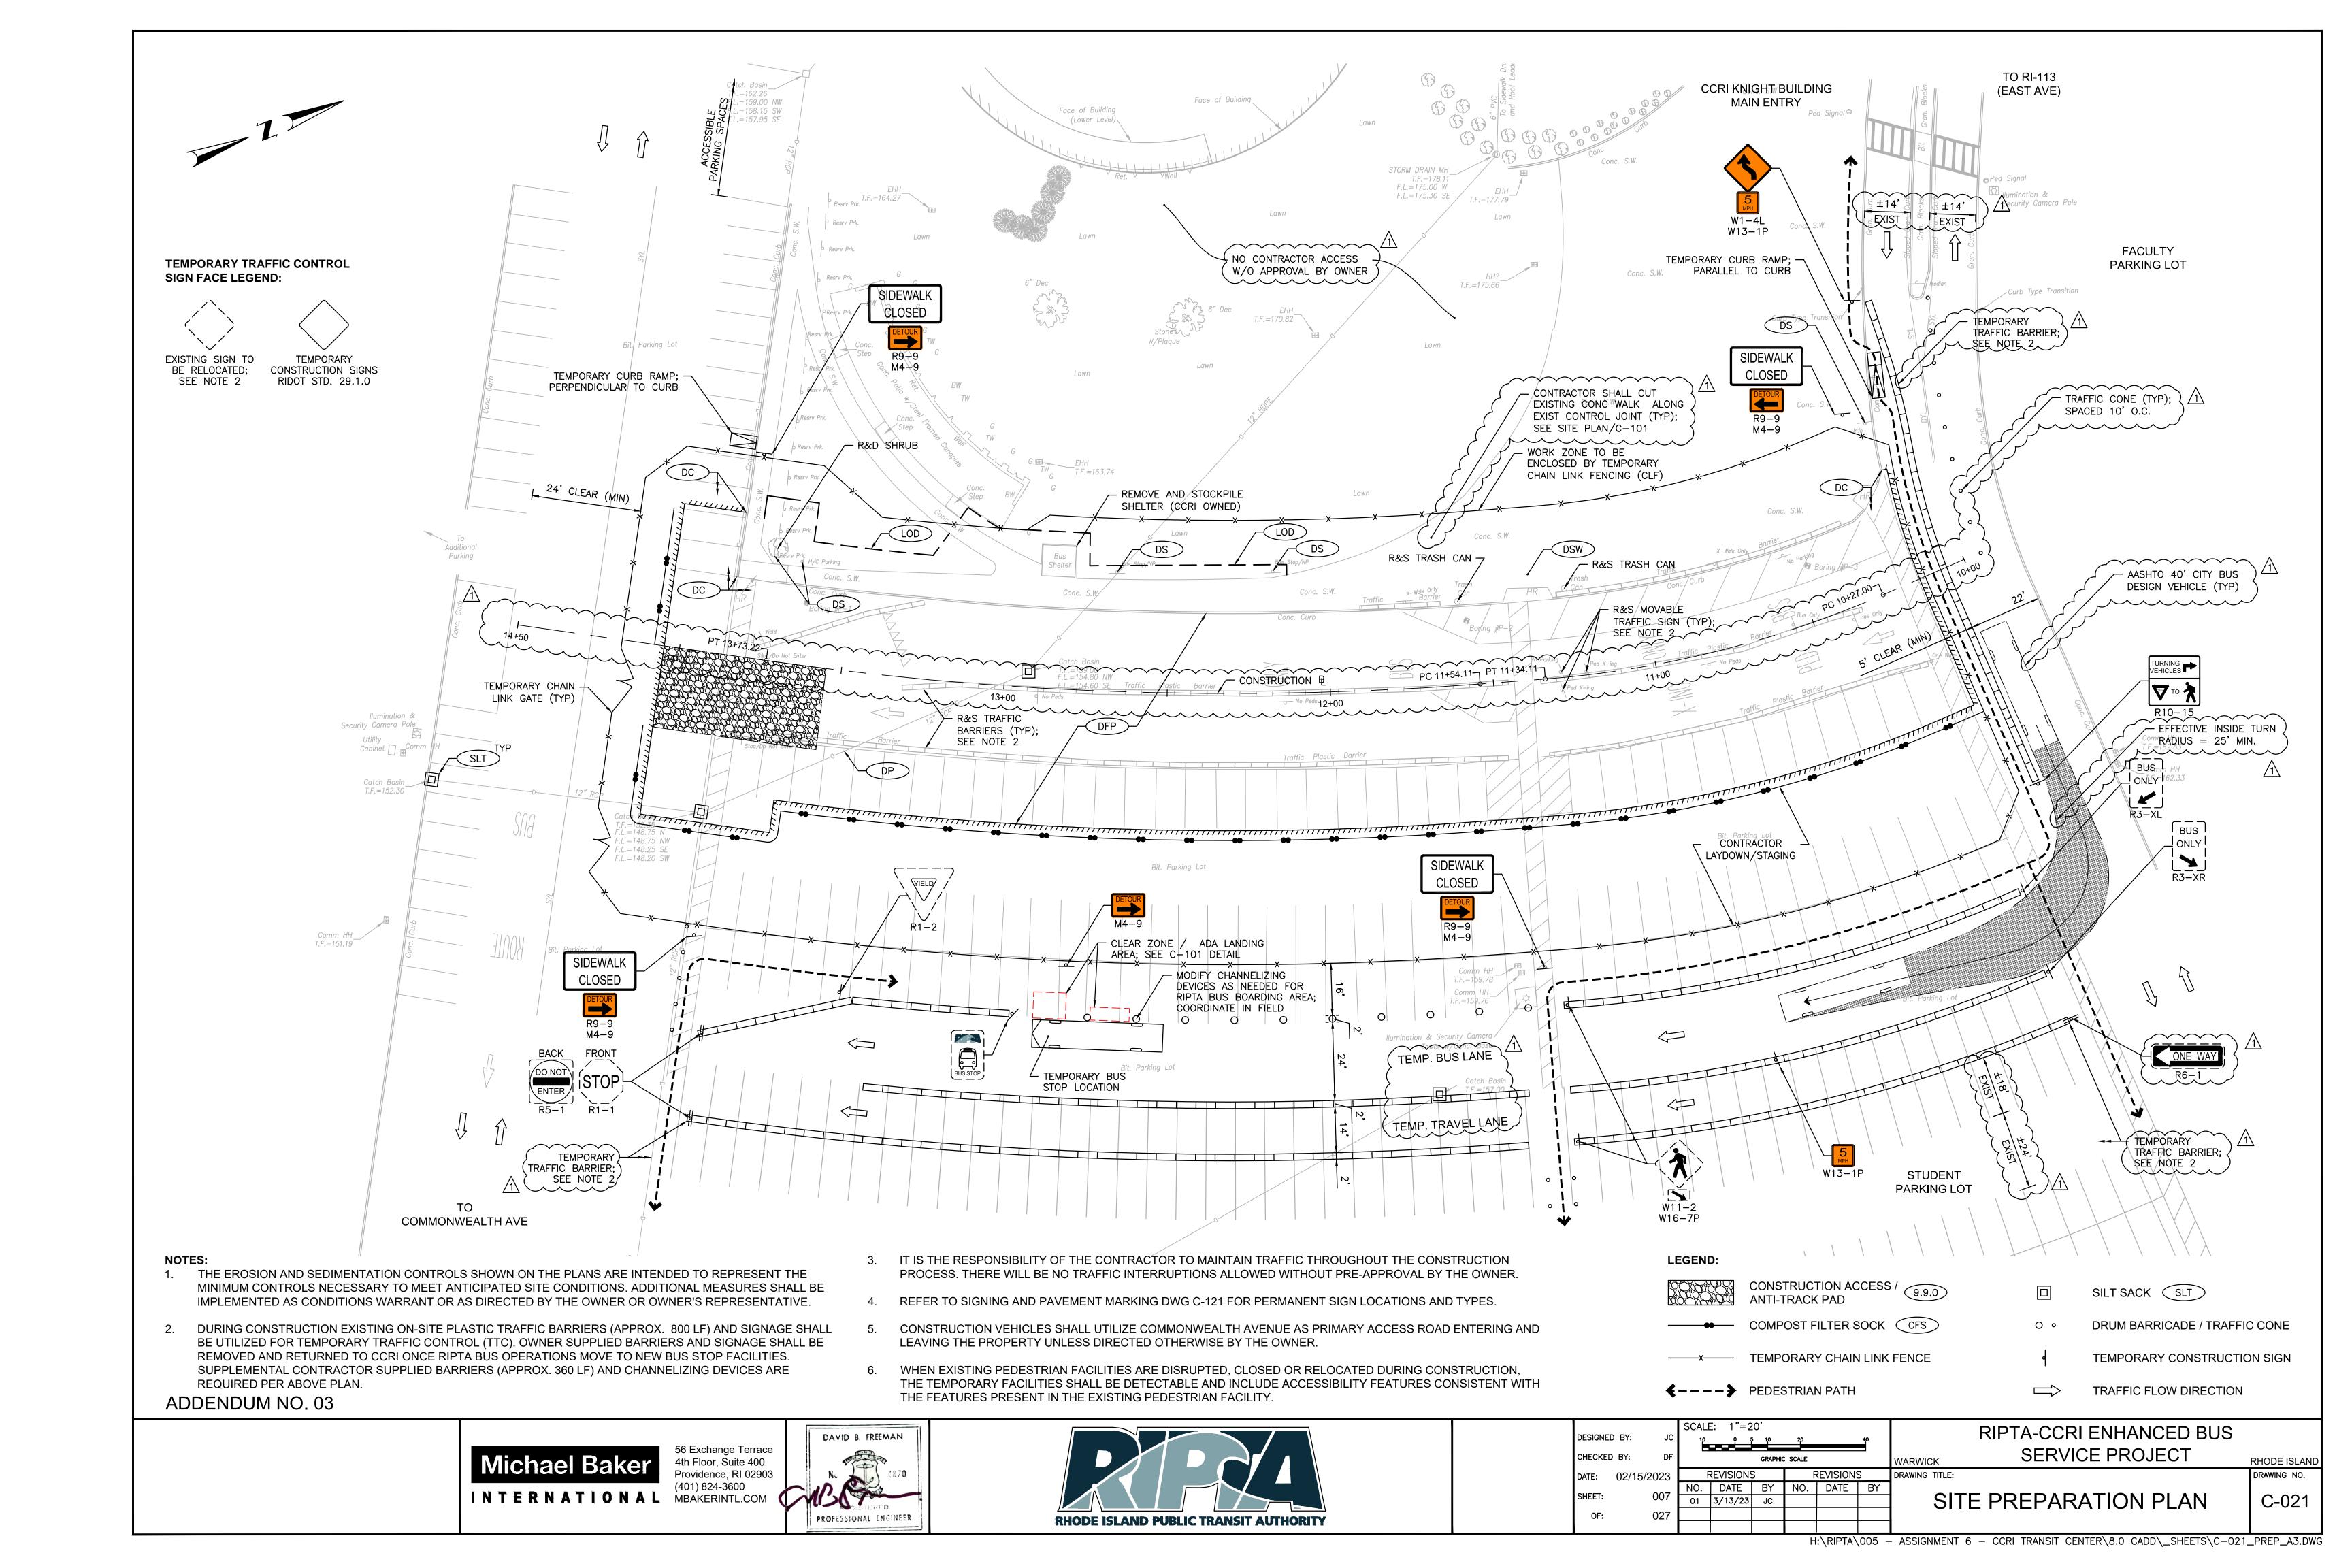
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Boring :	# P-3		Proj		PTA - CCRI	,		Project # 49587
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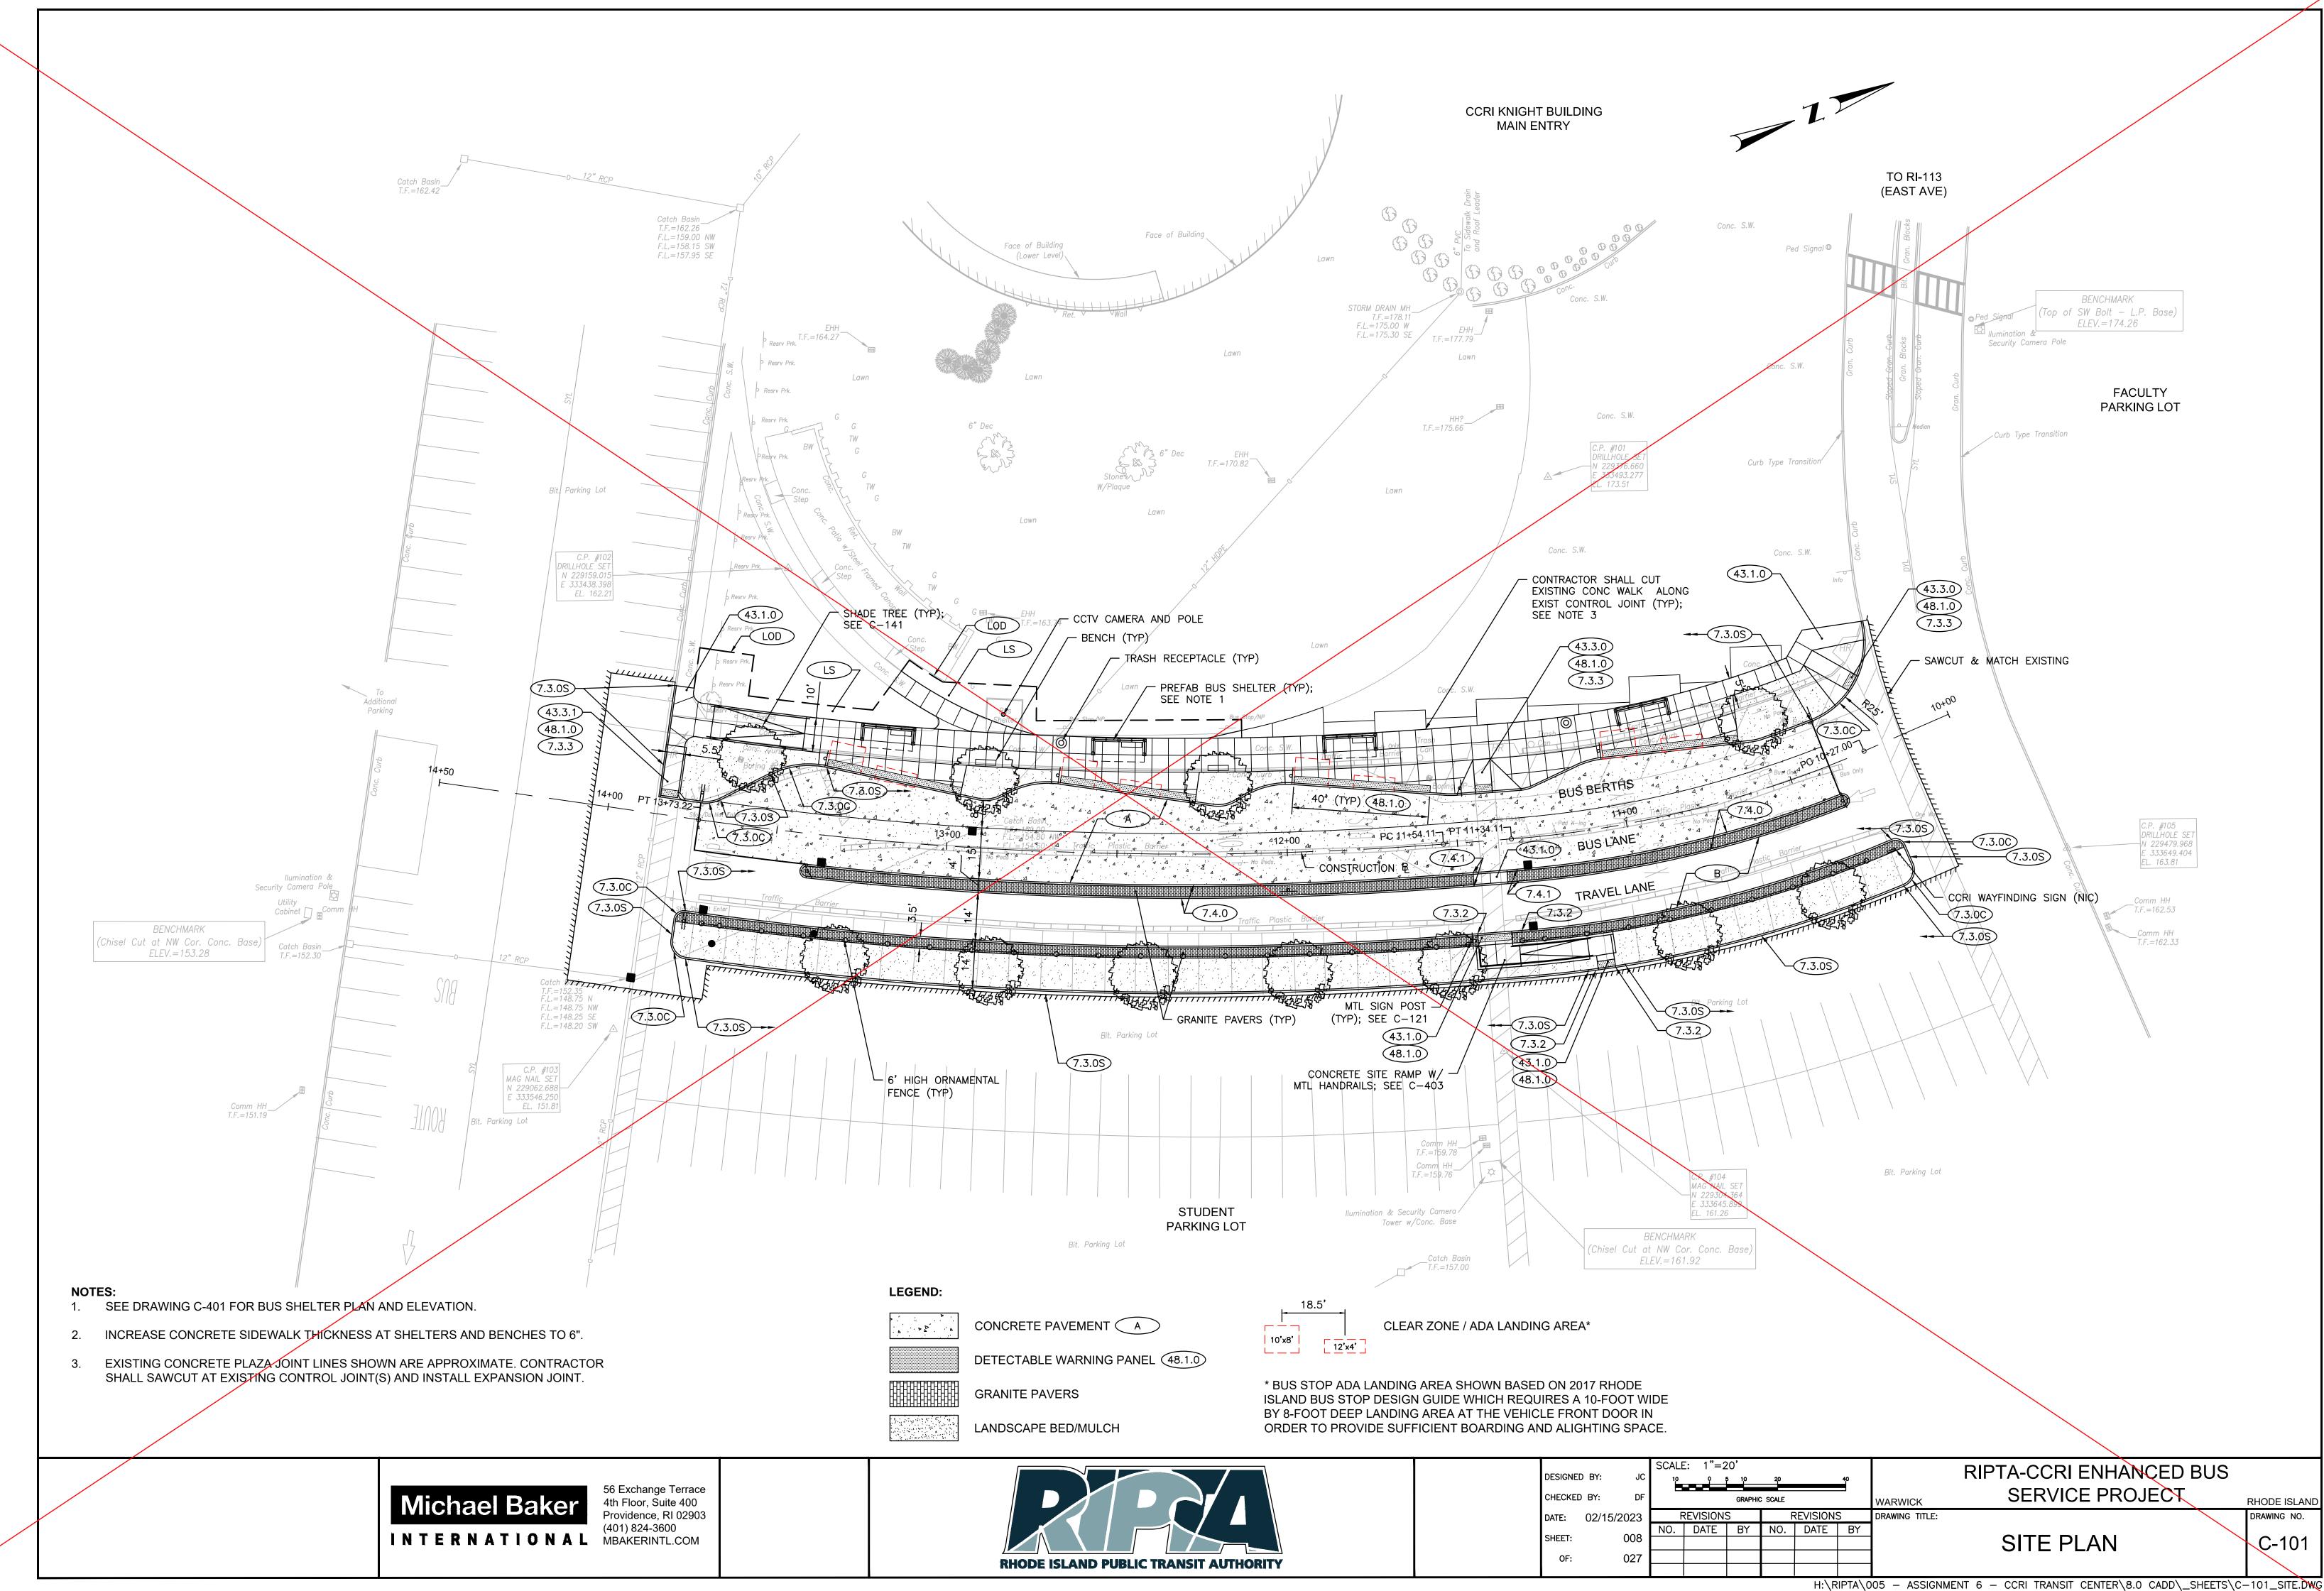














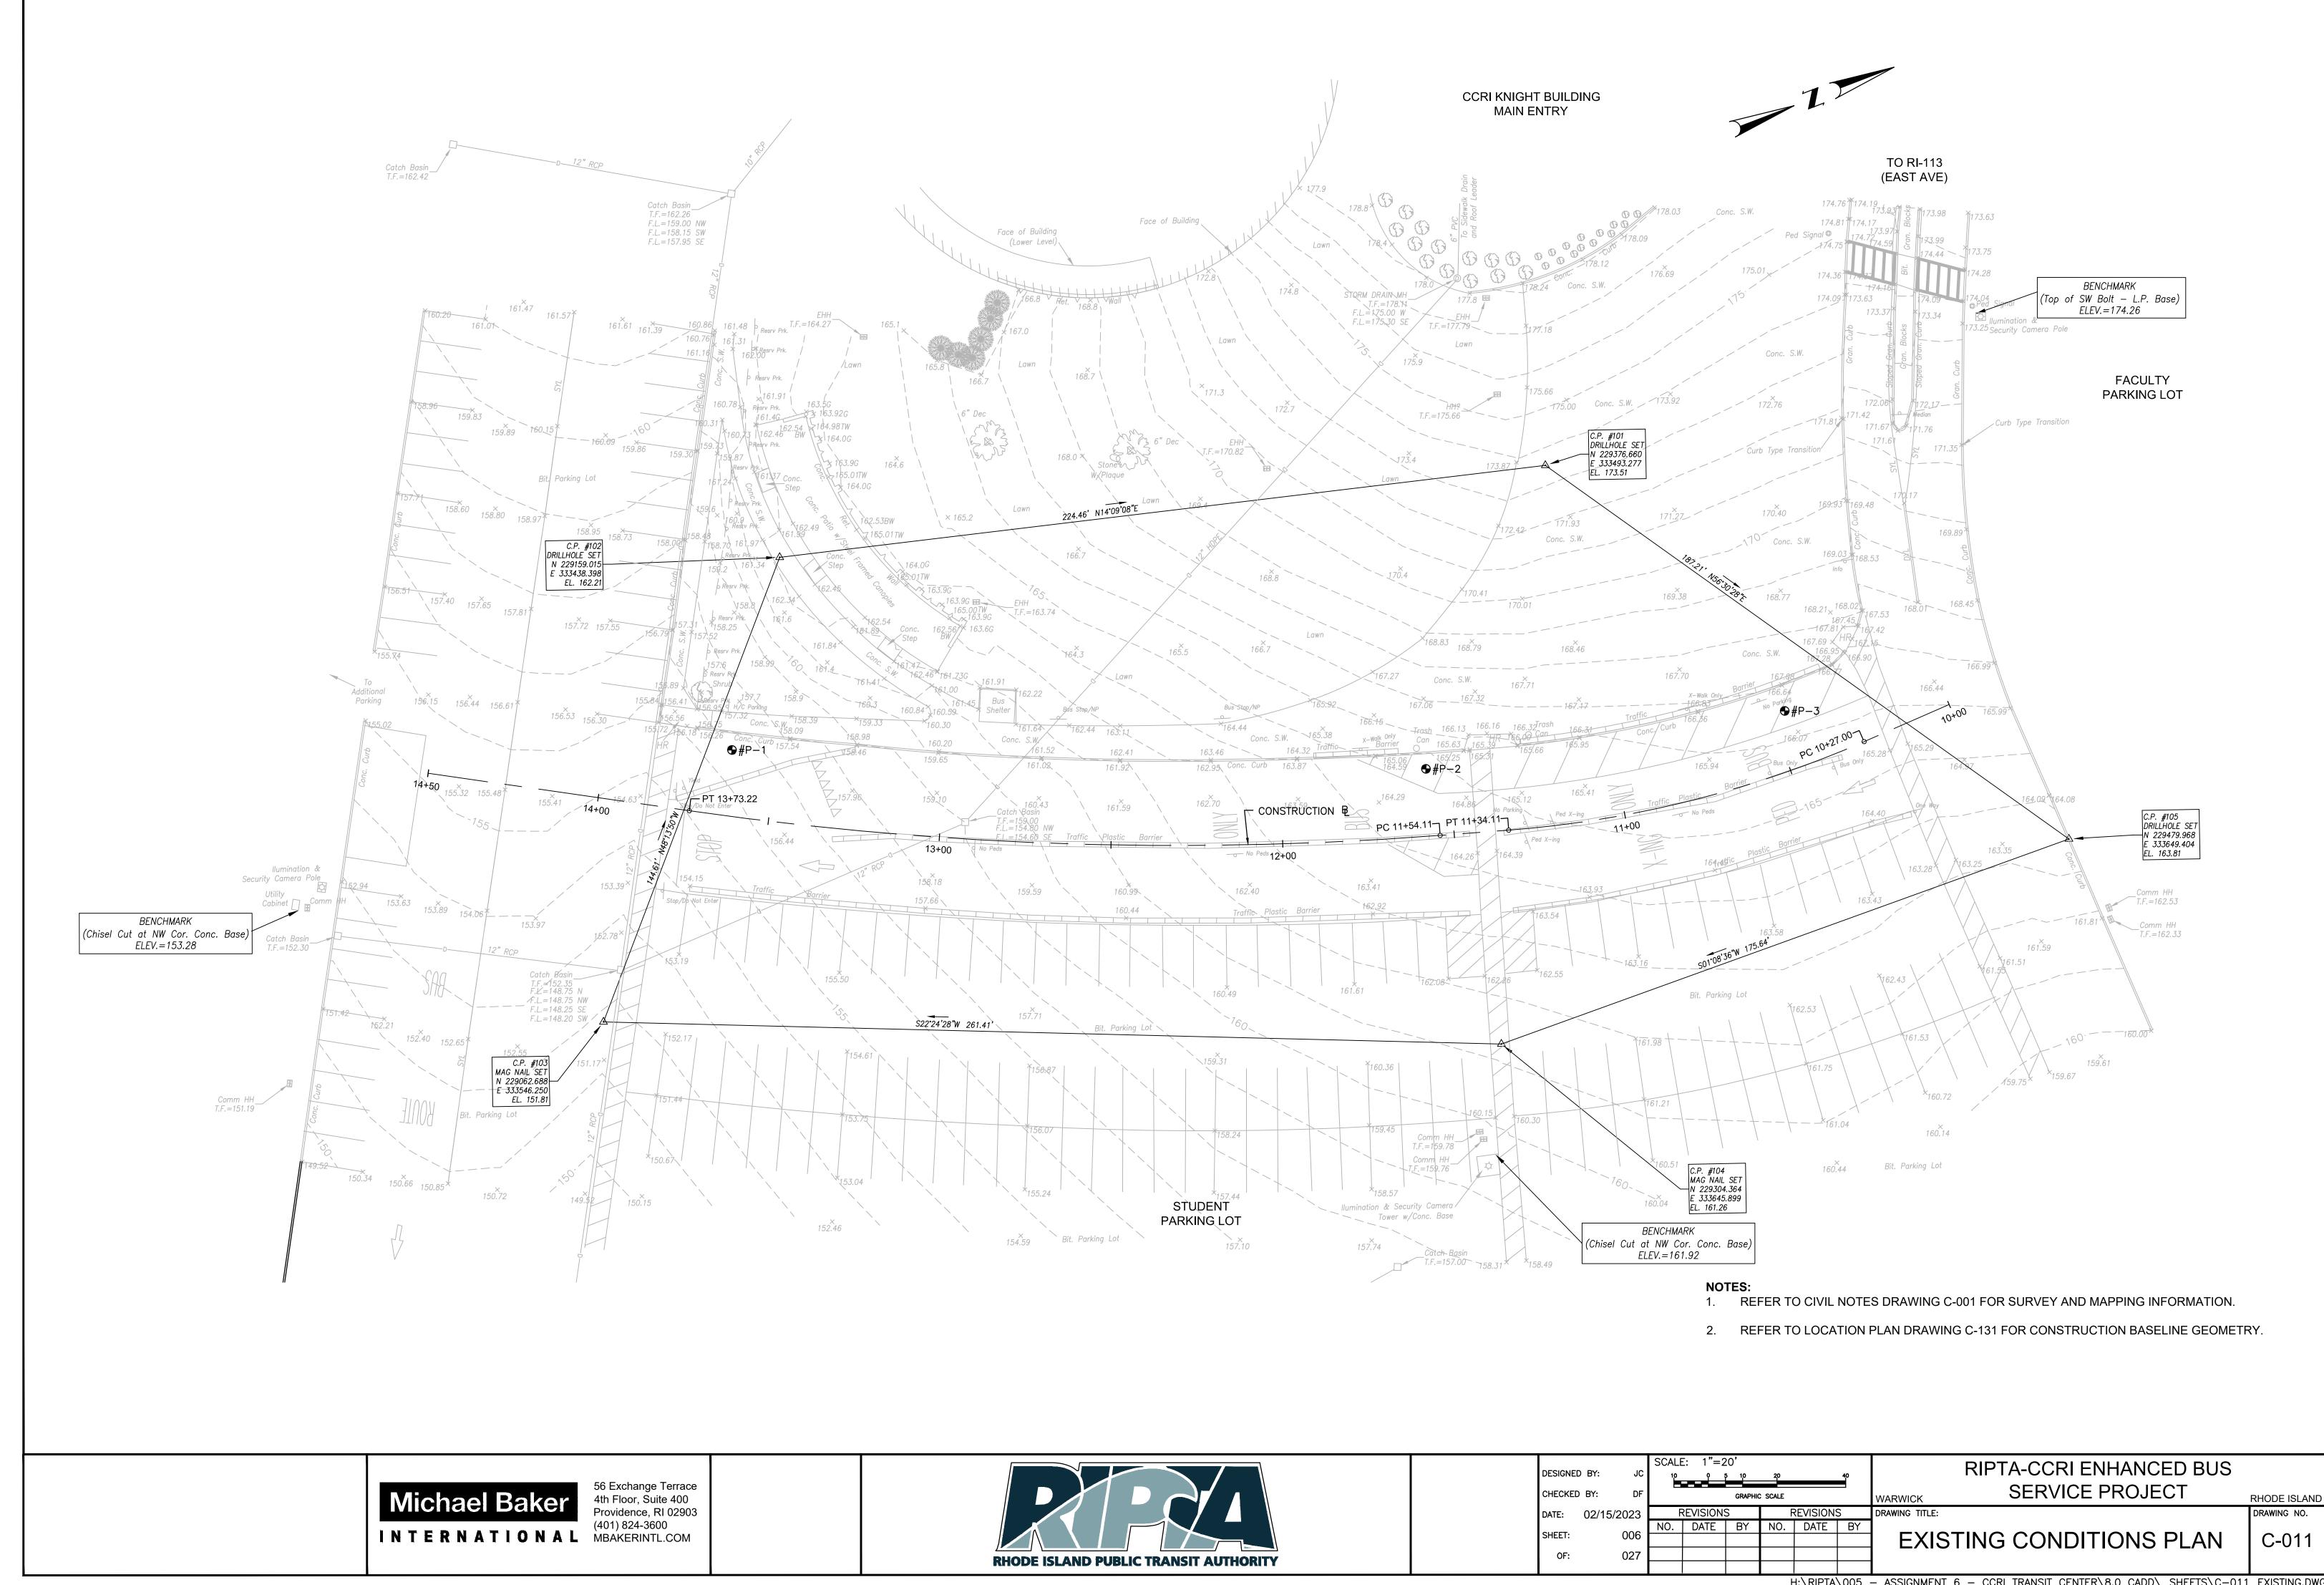


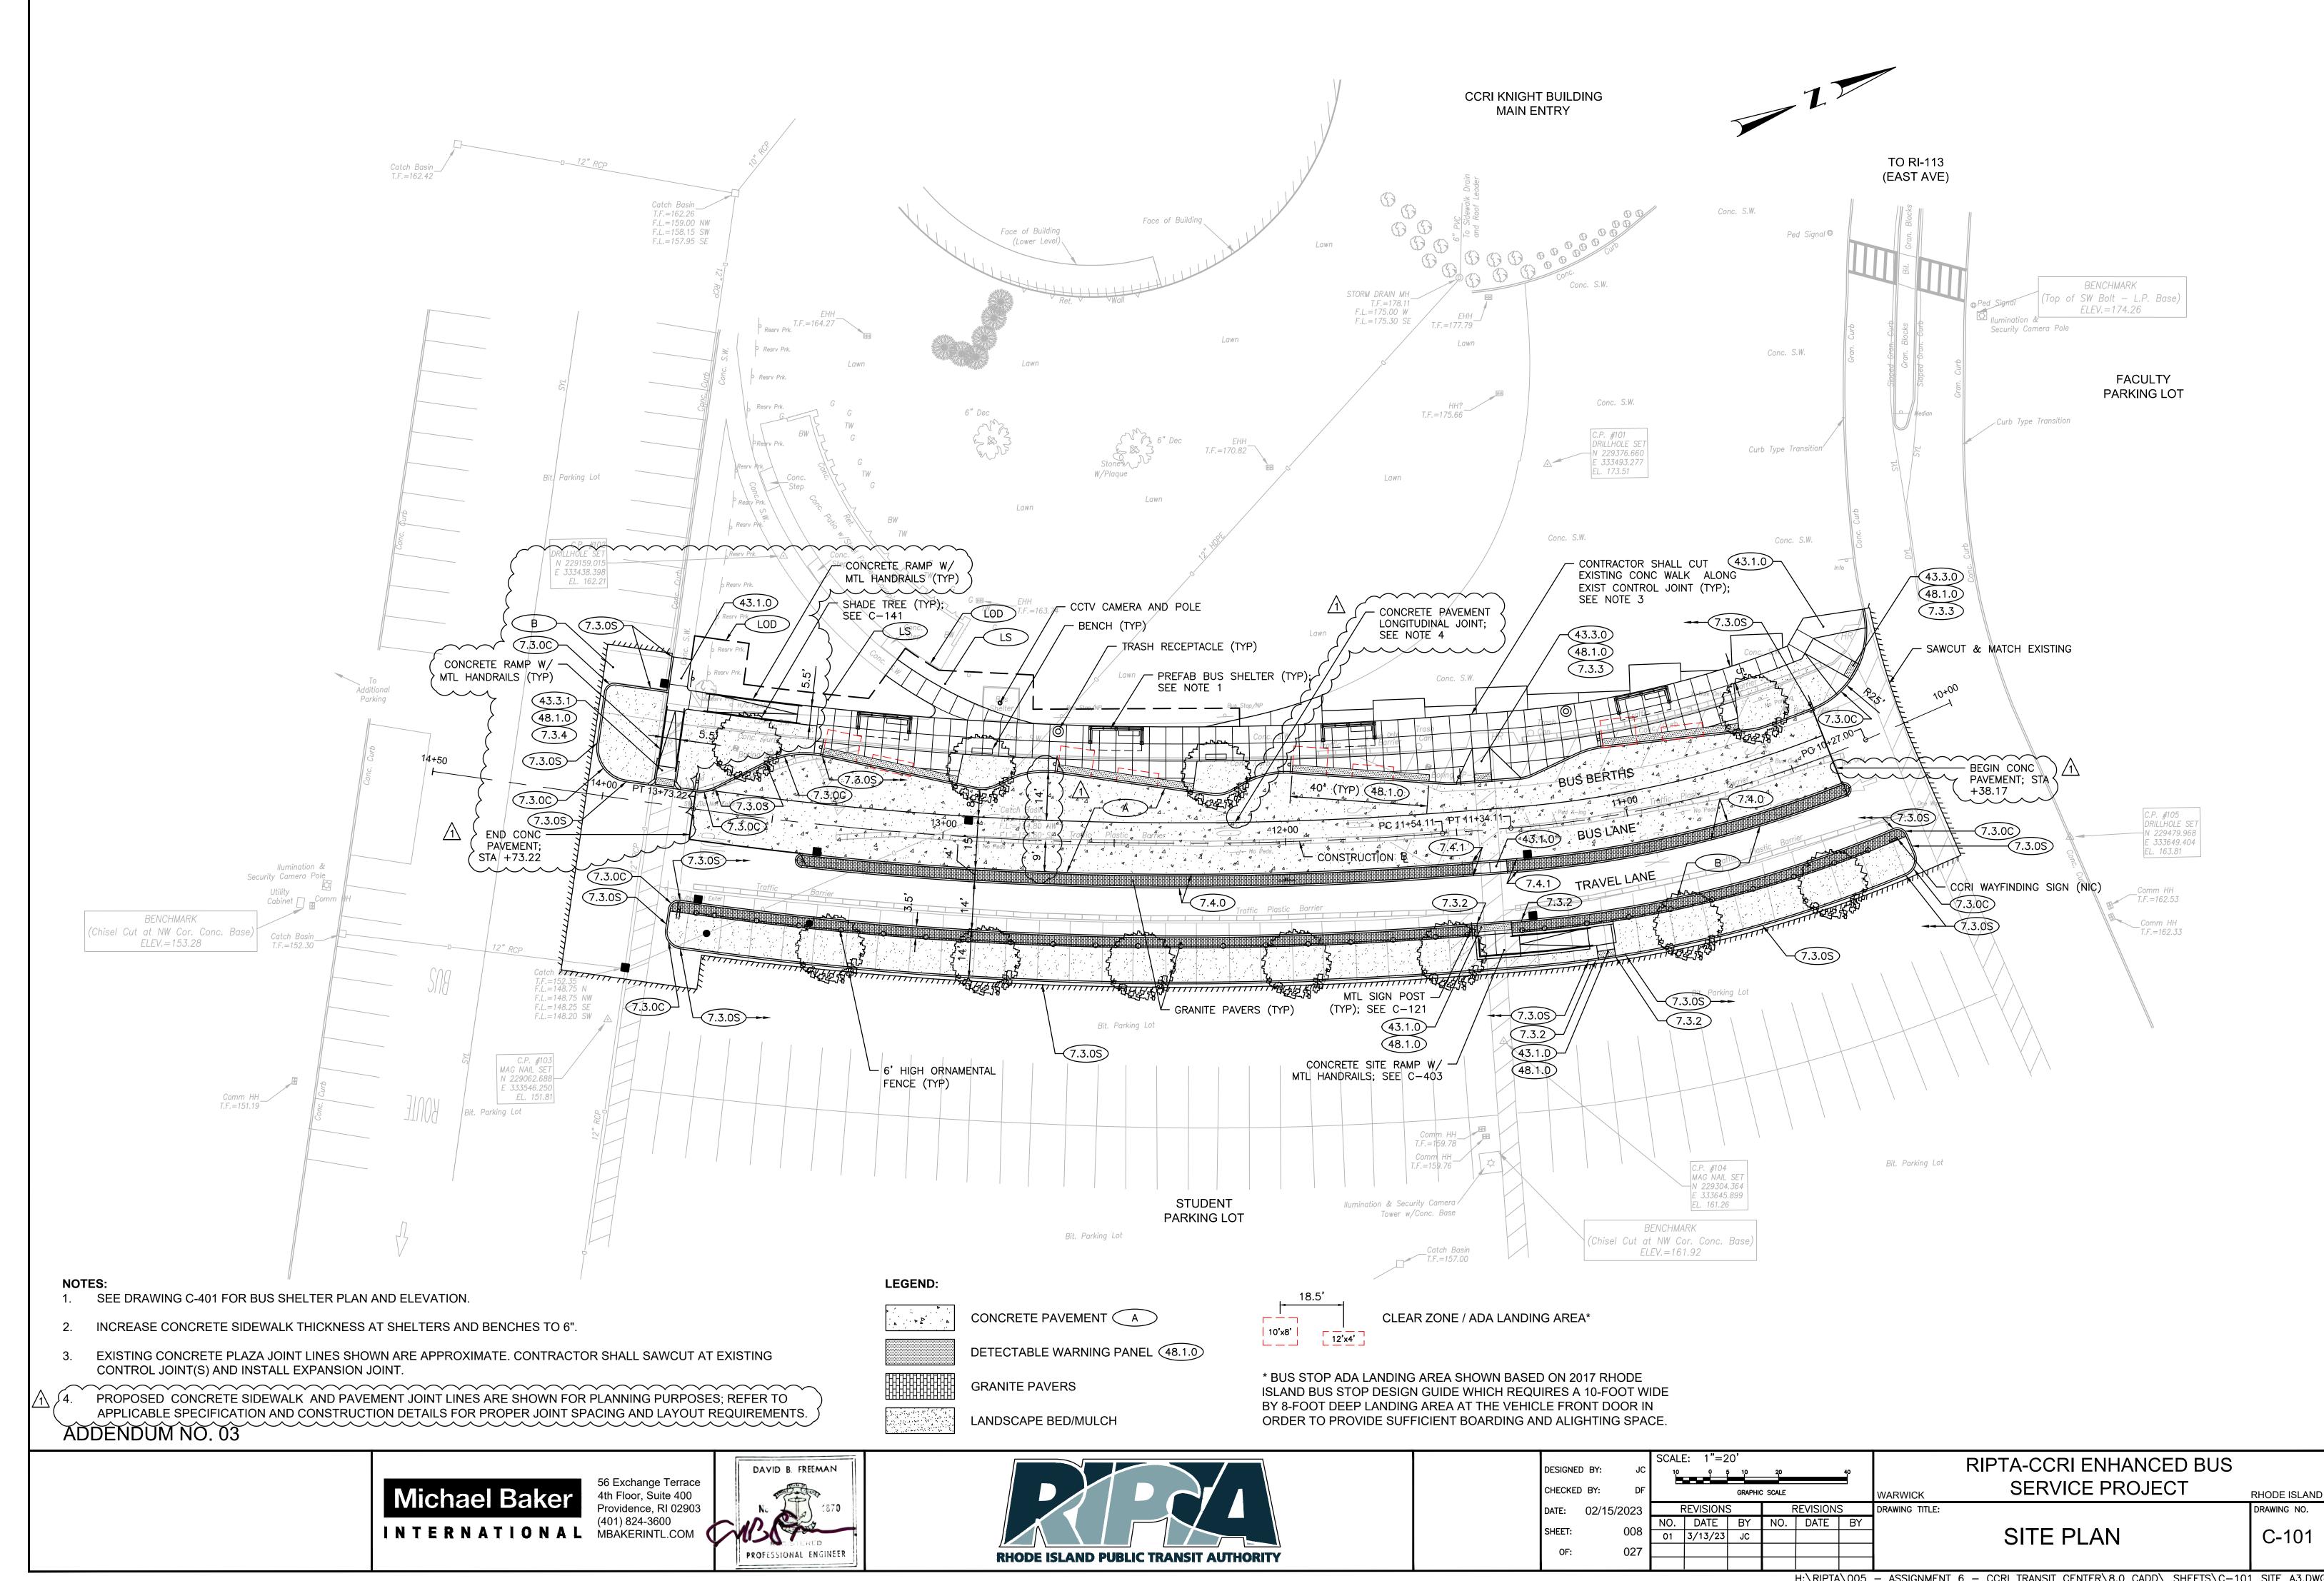

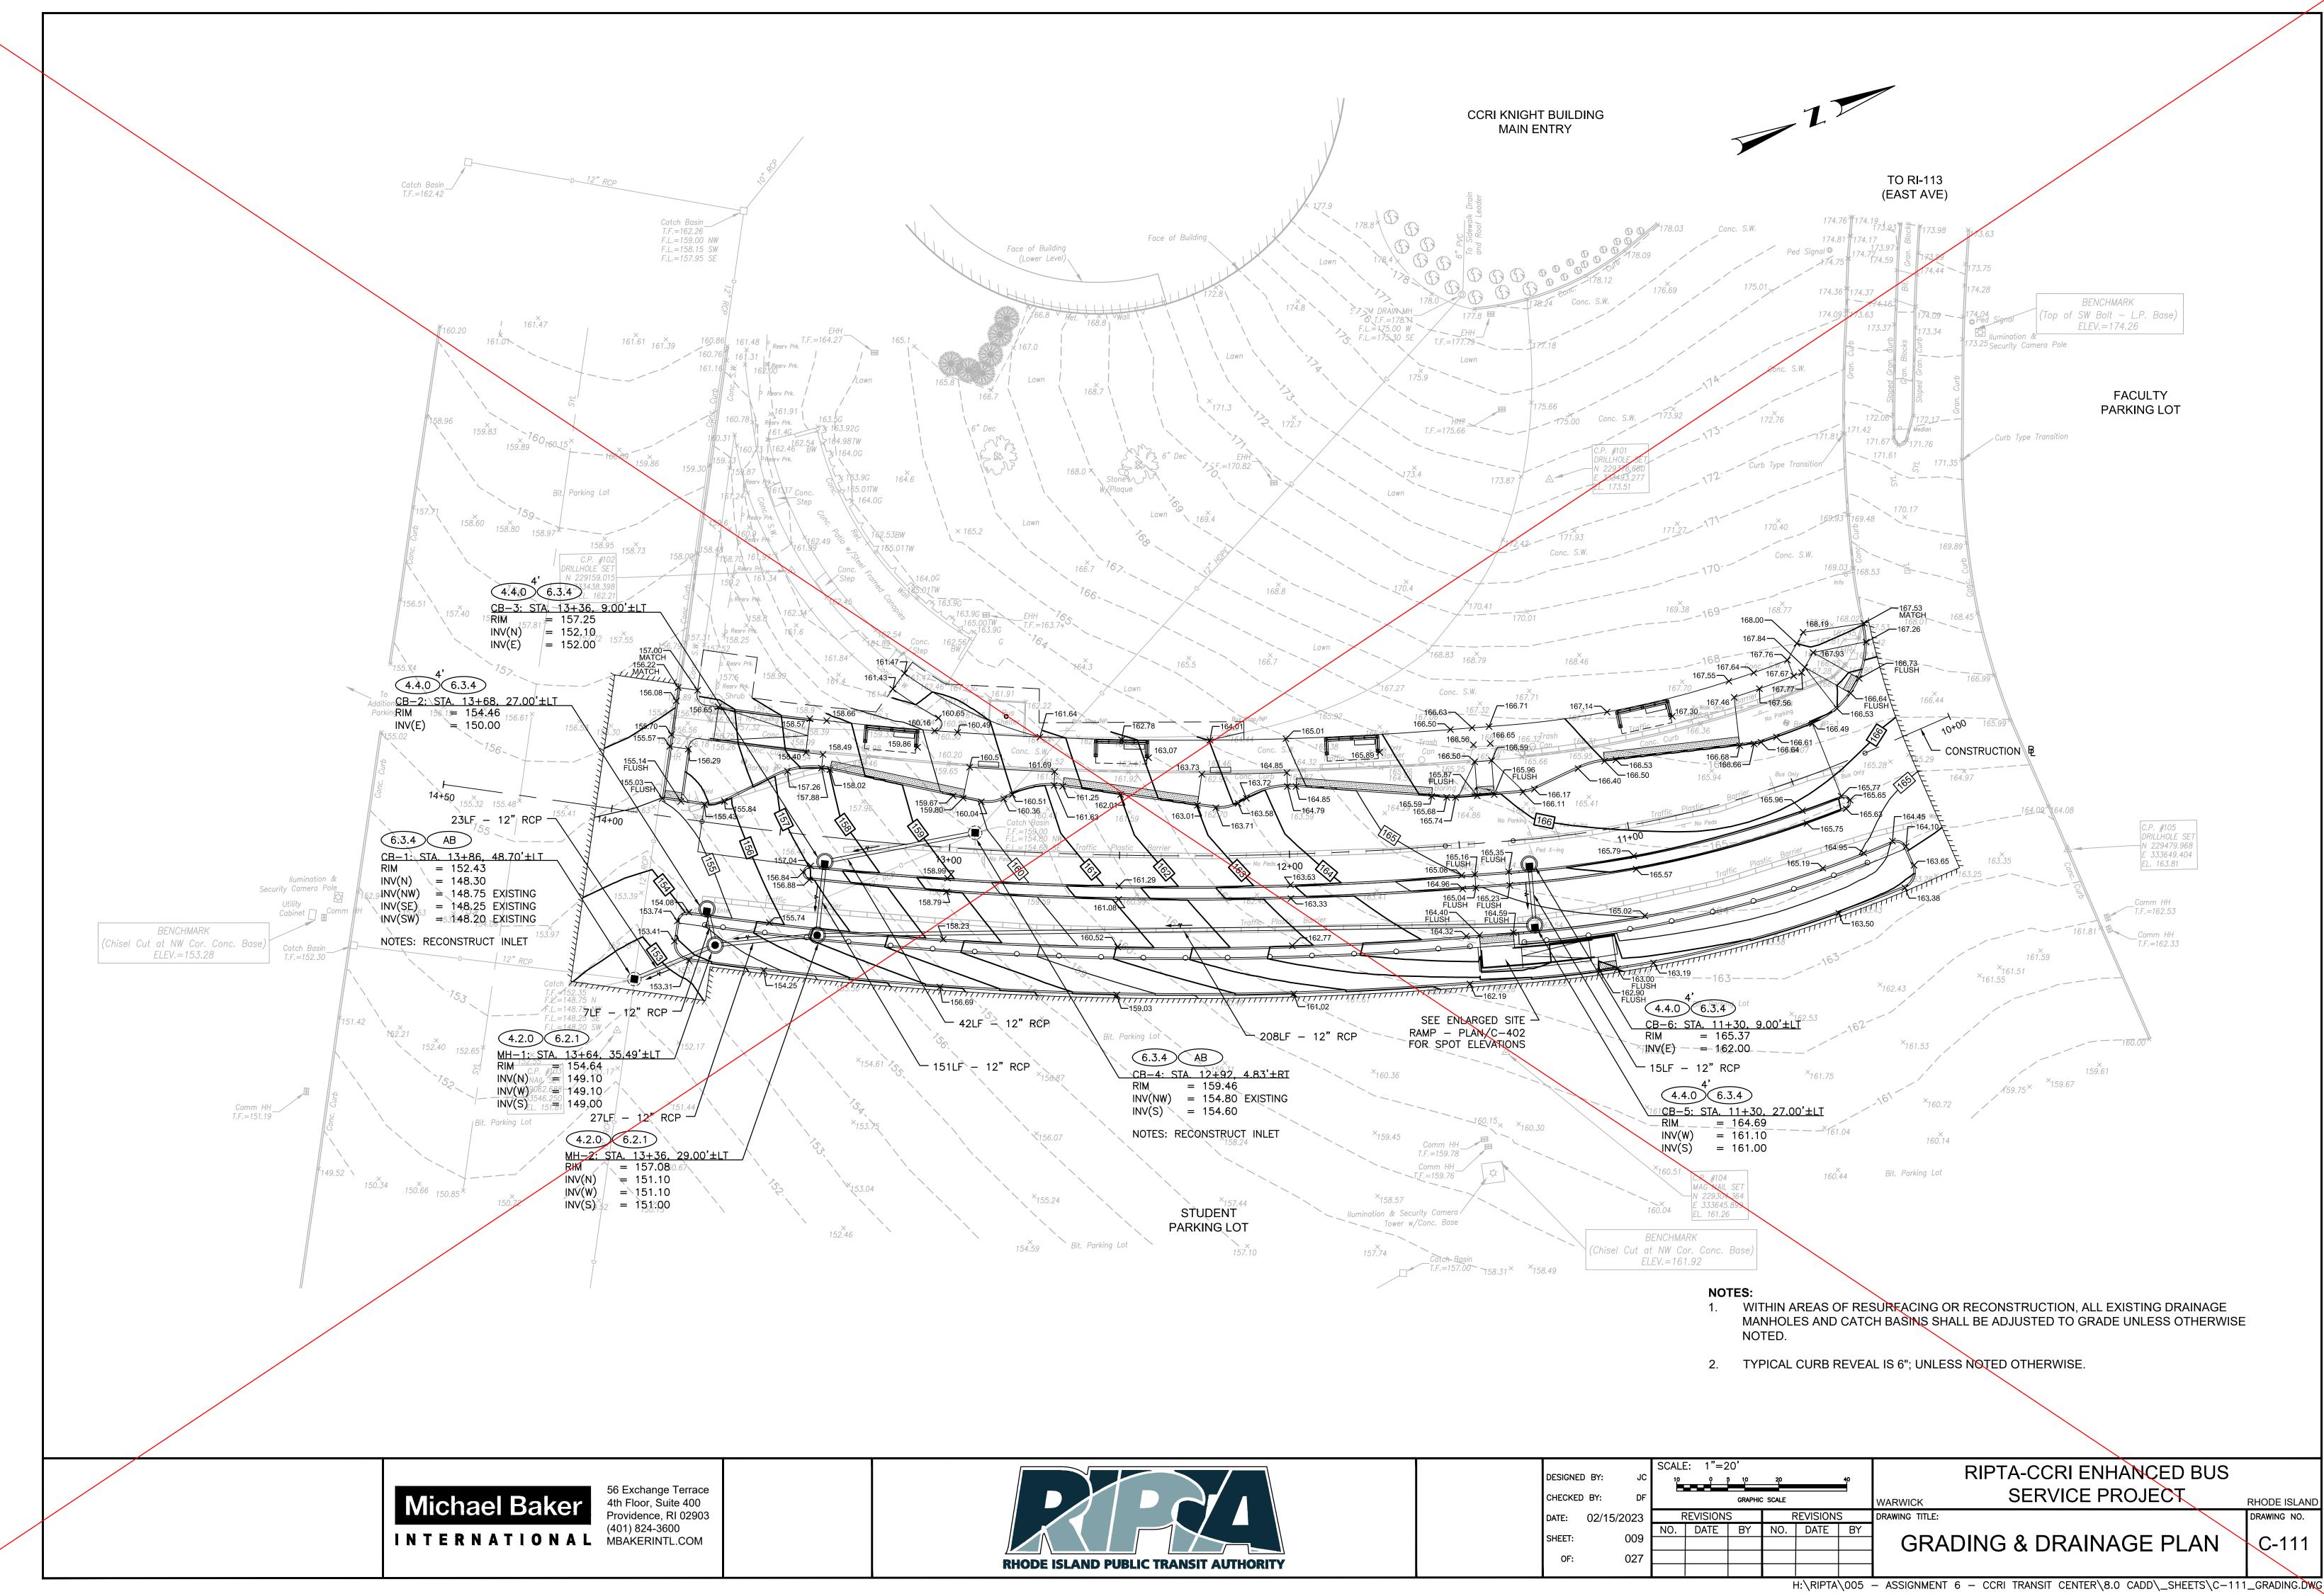

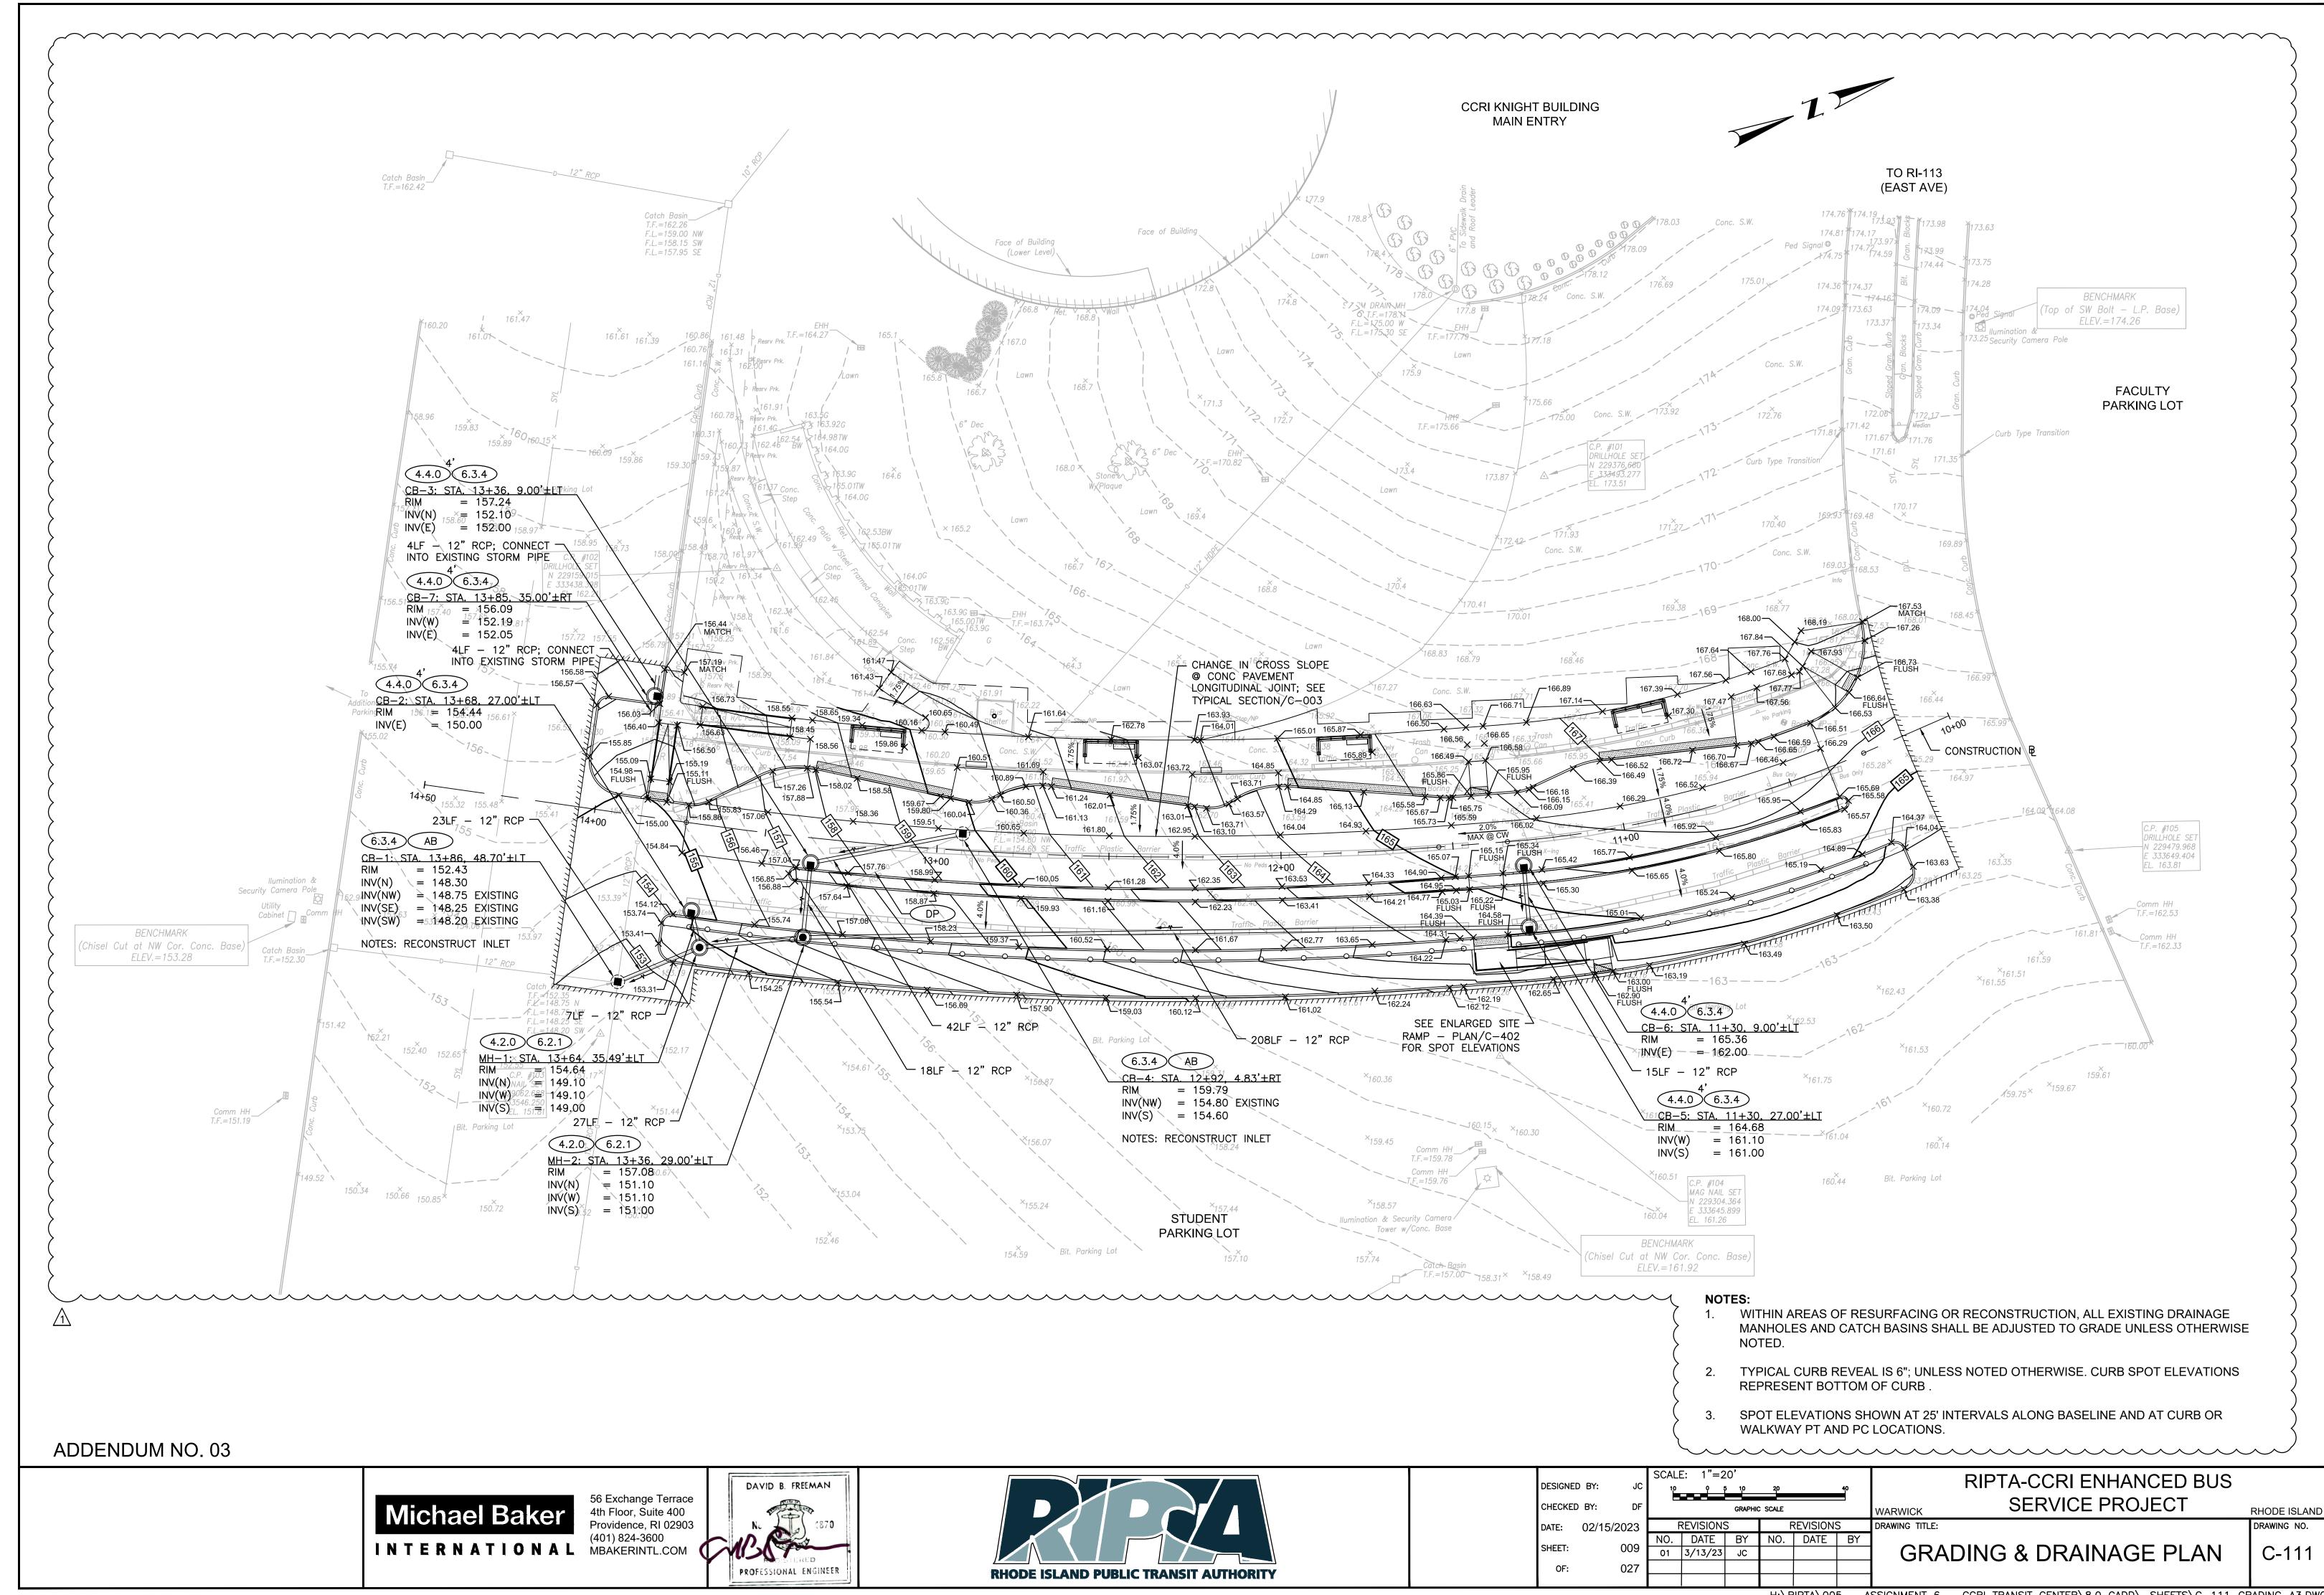

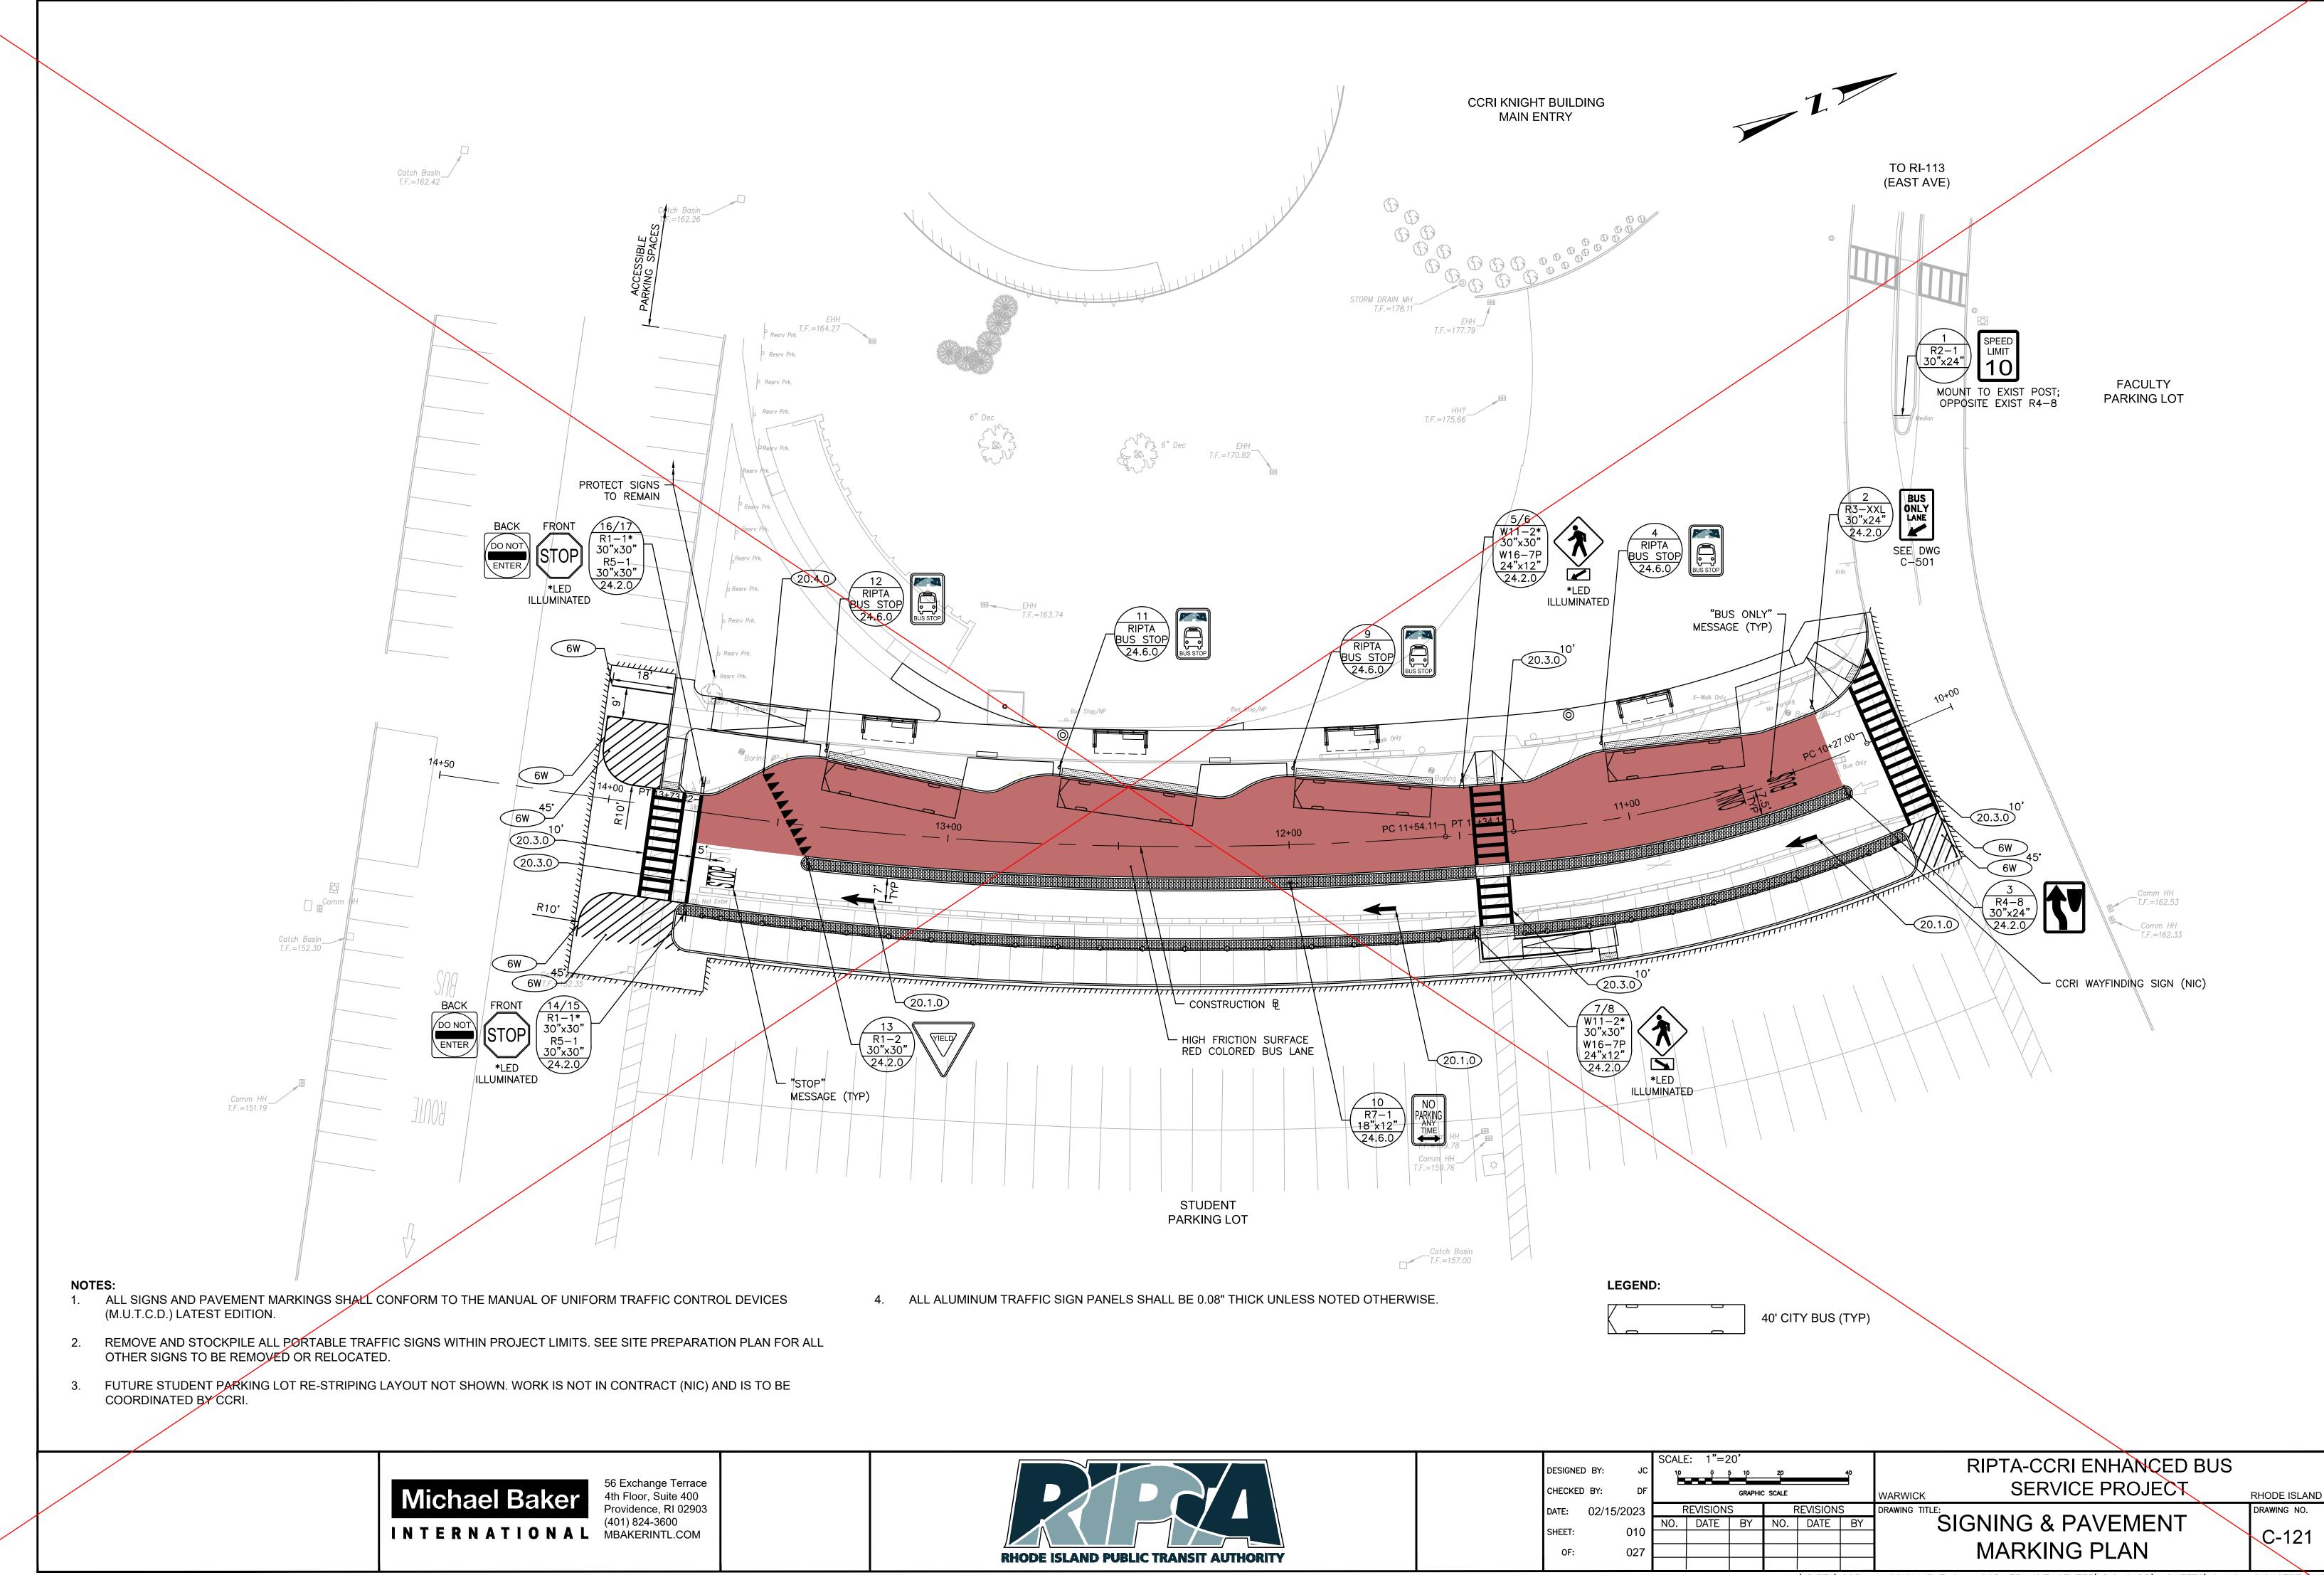


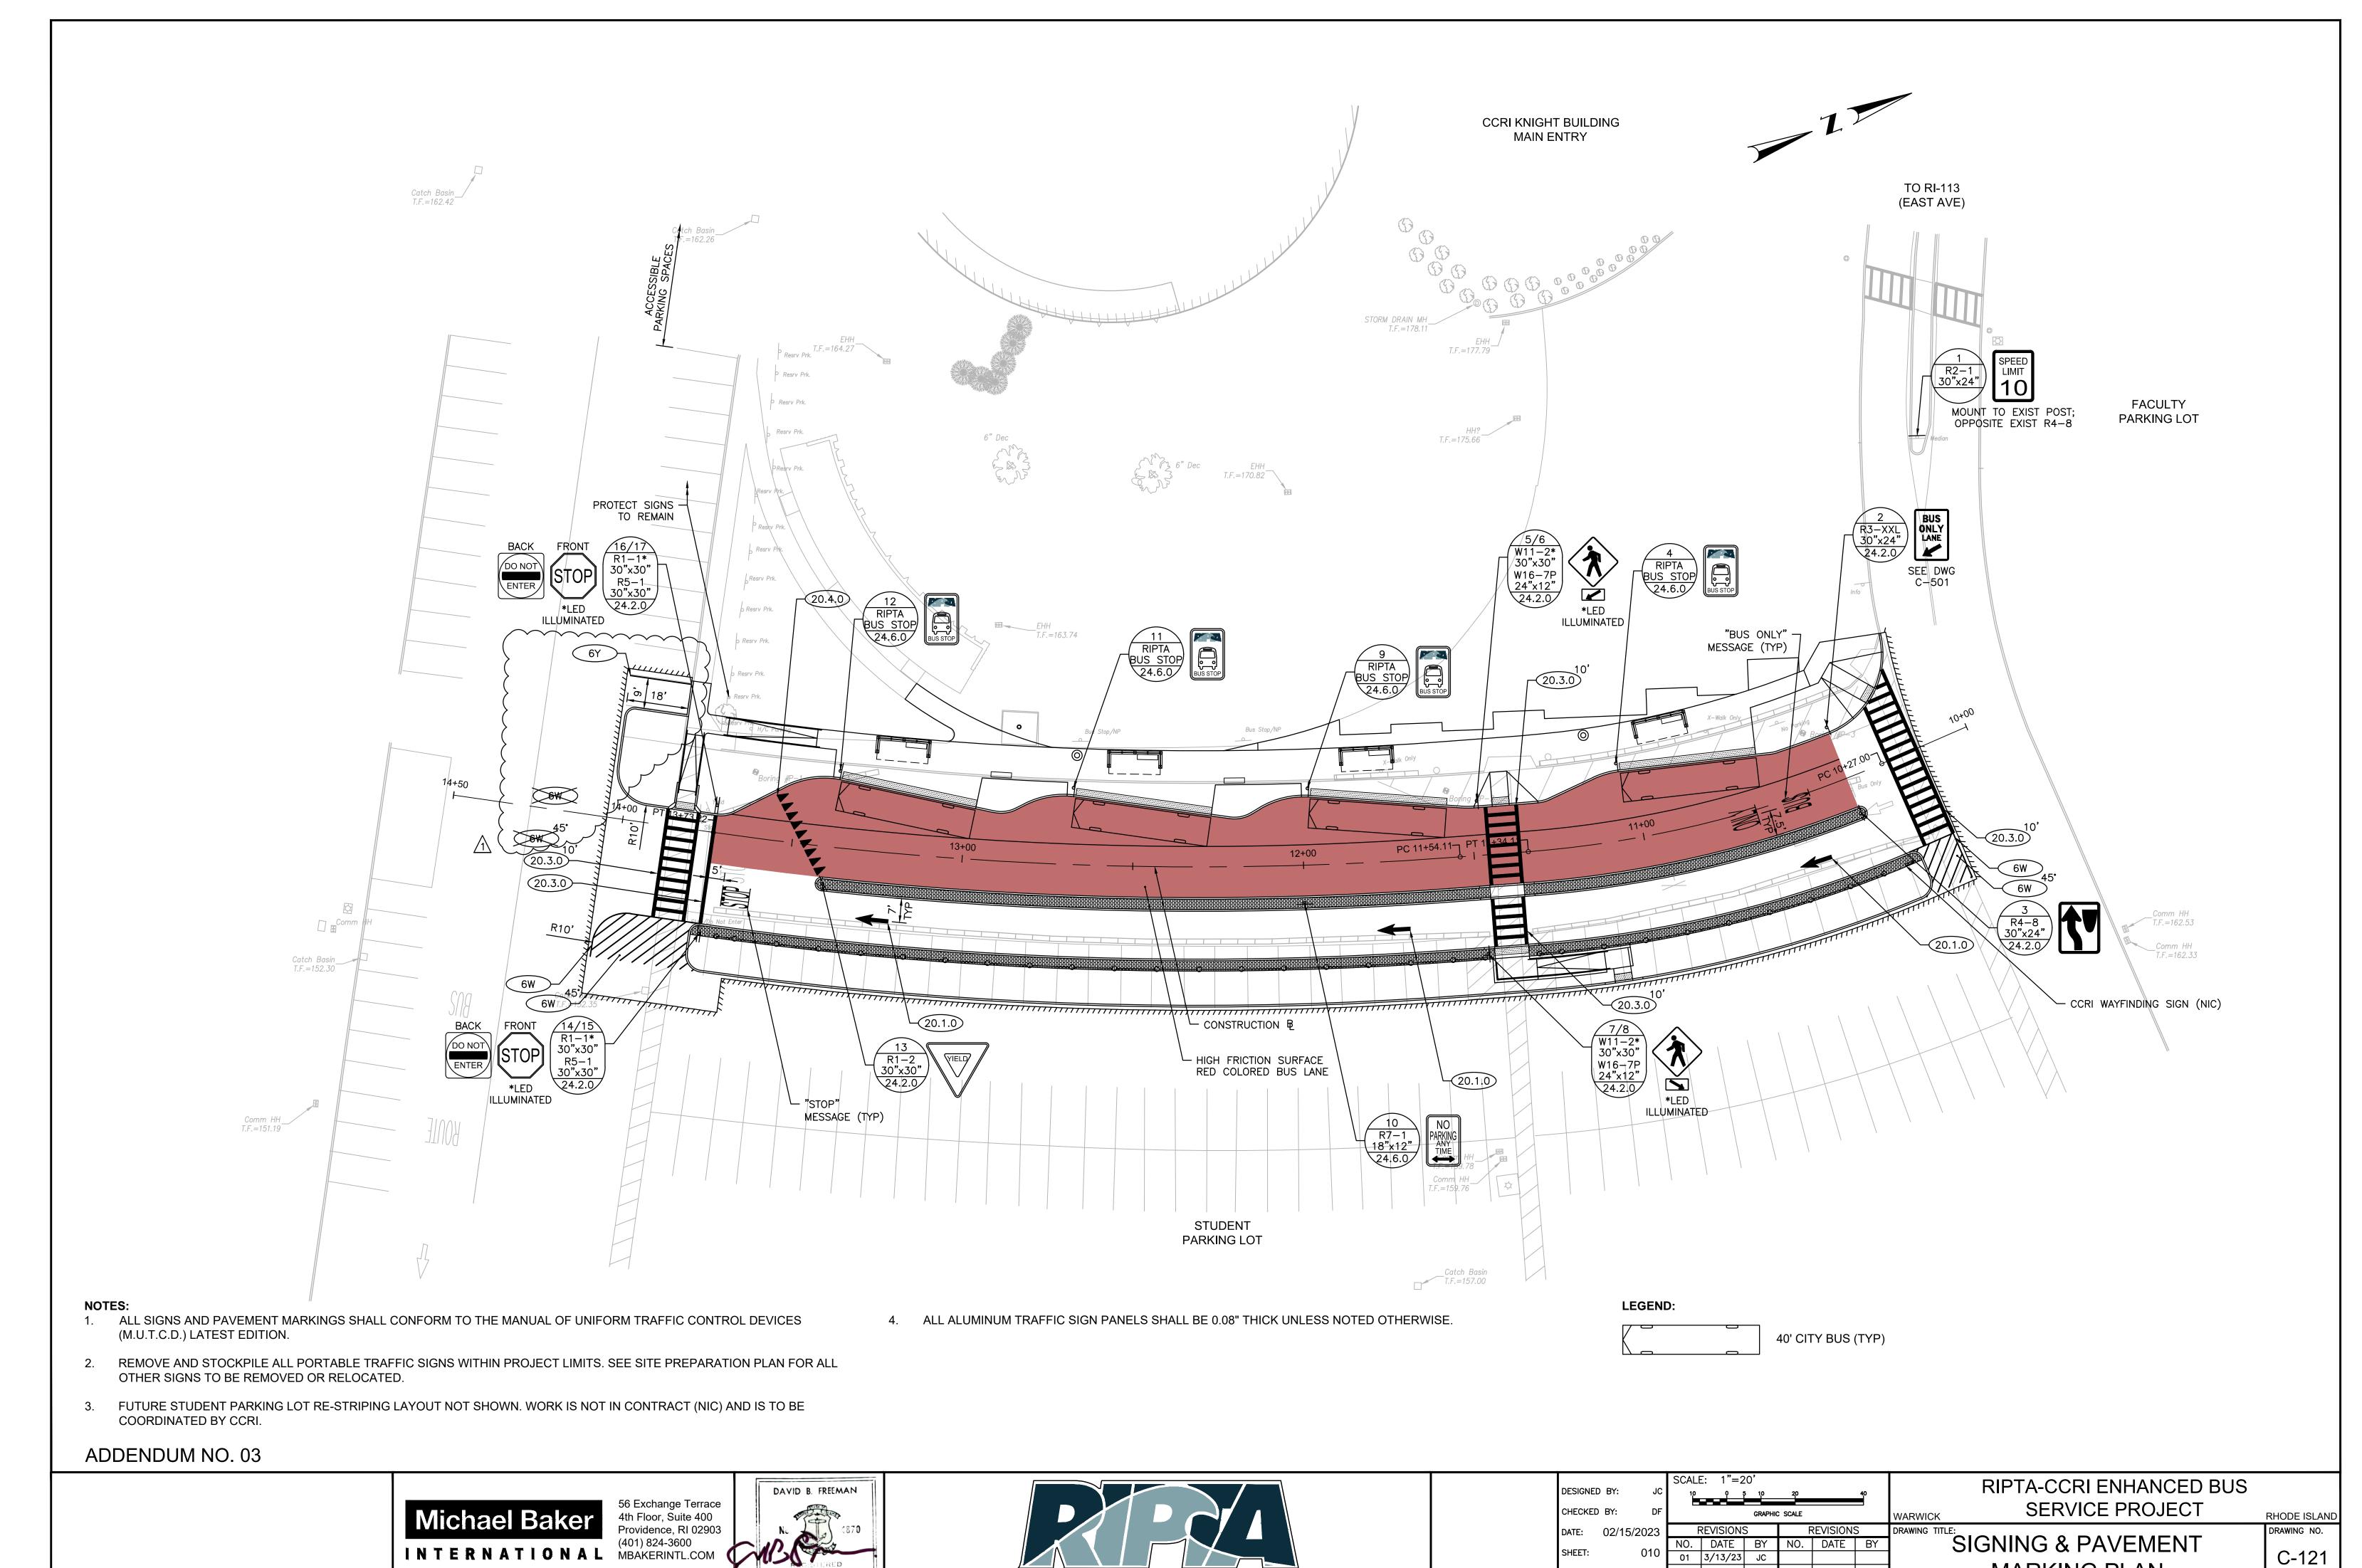



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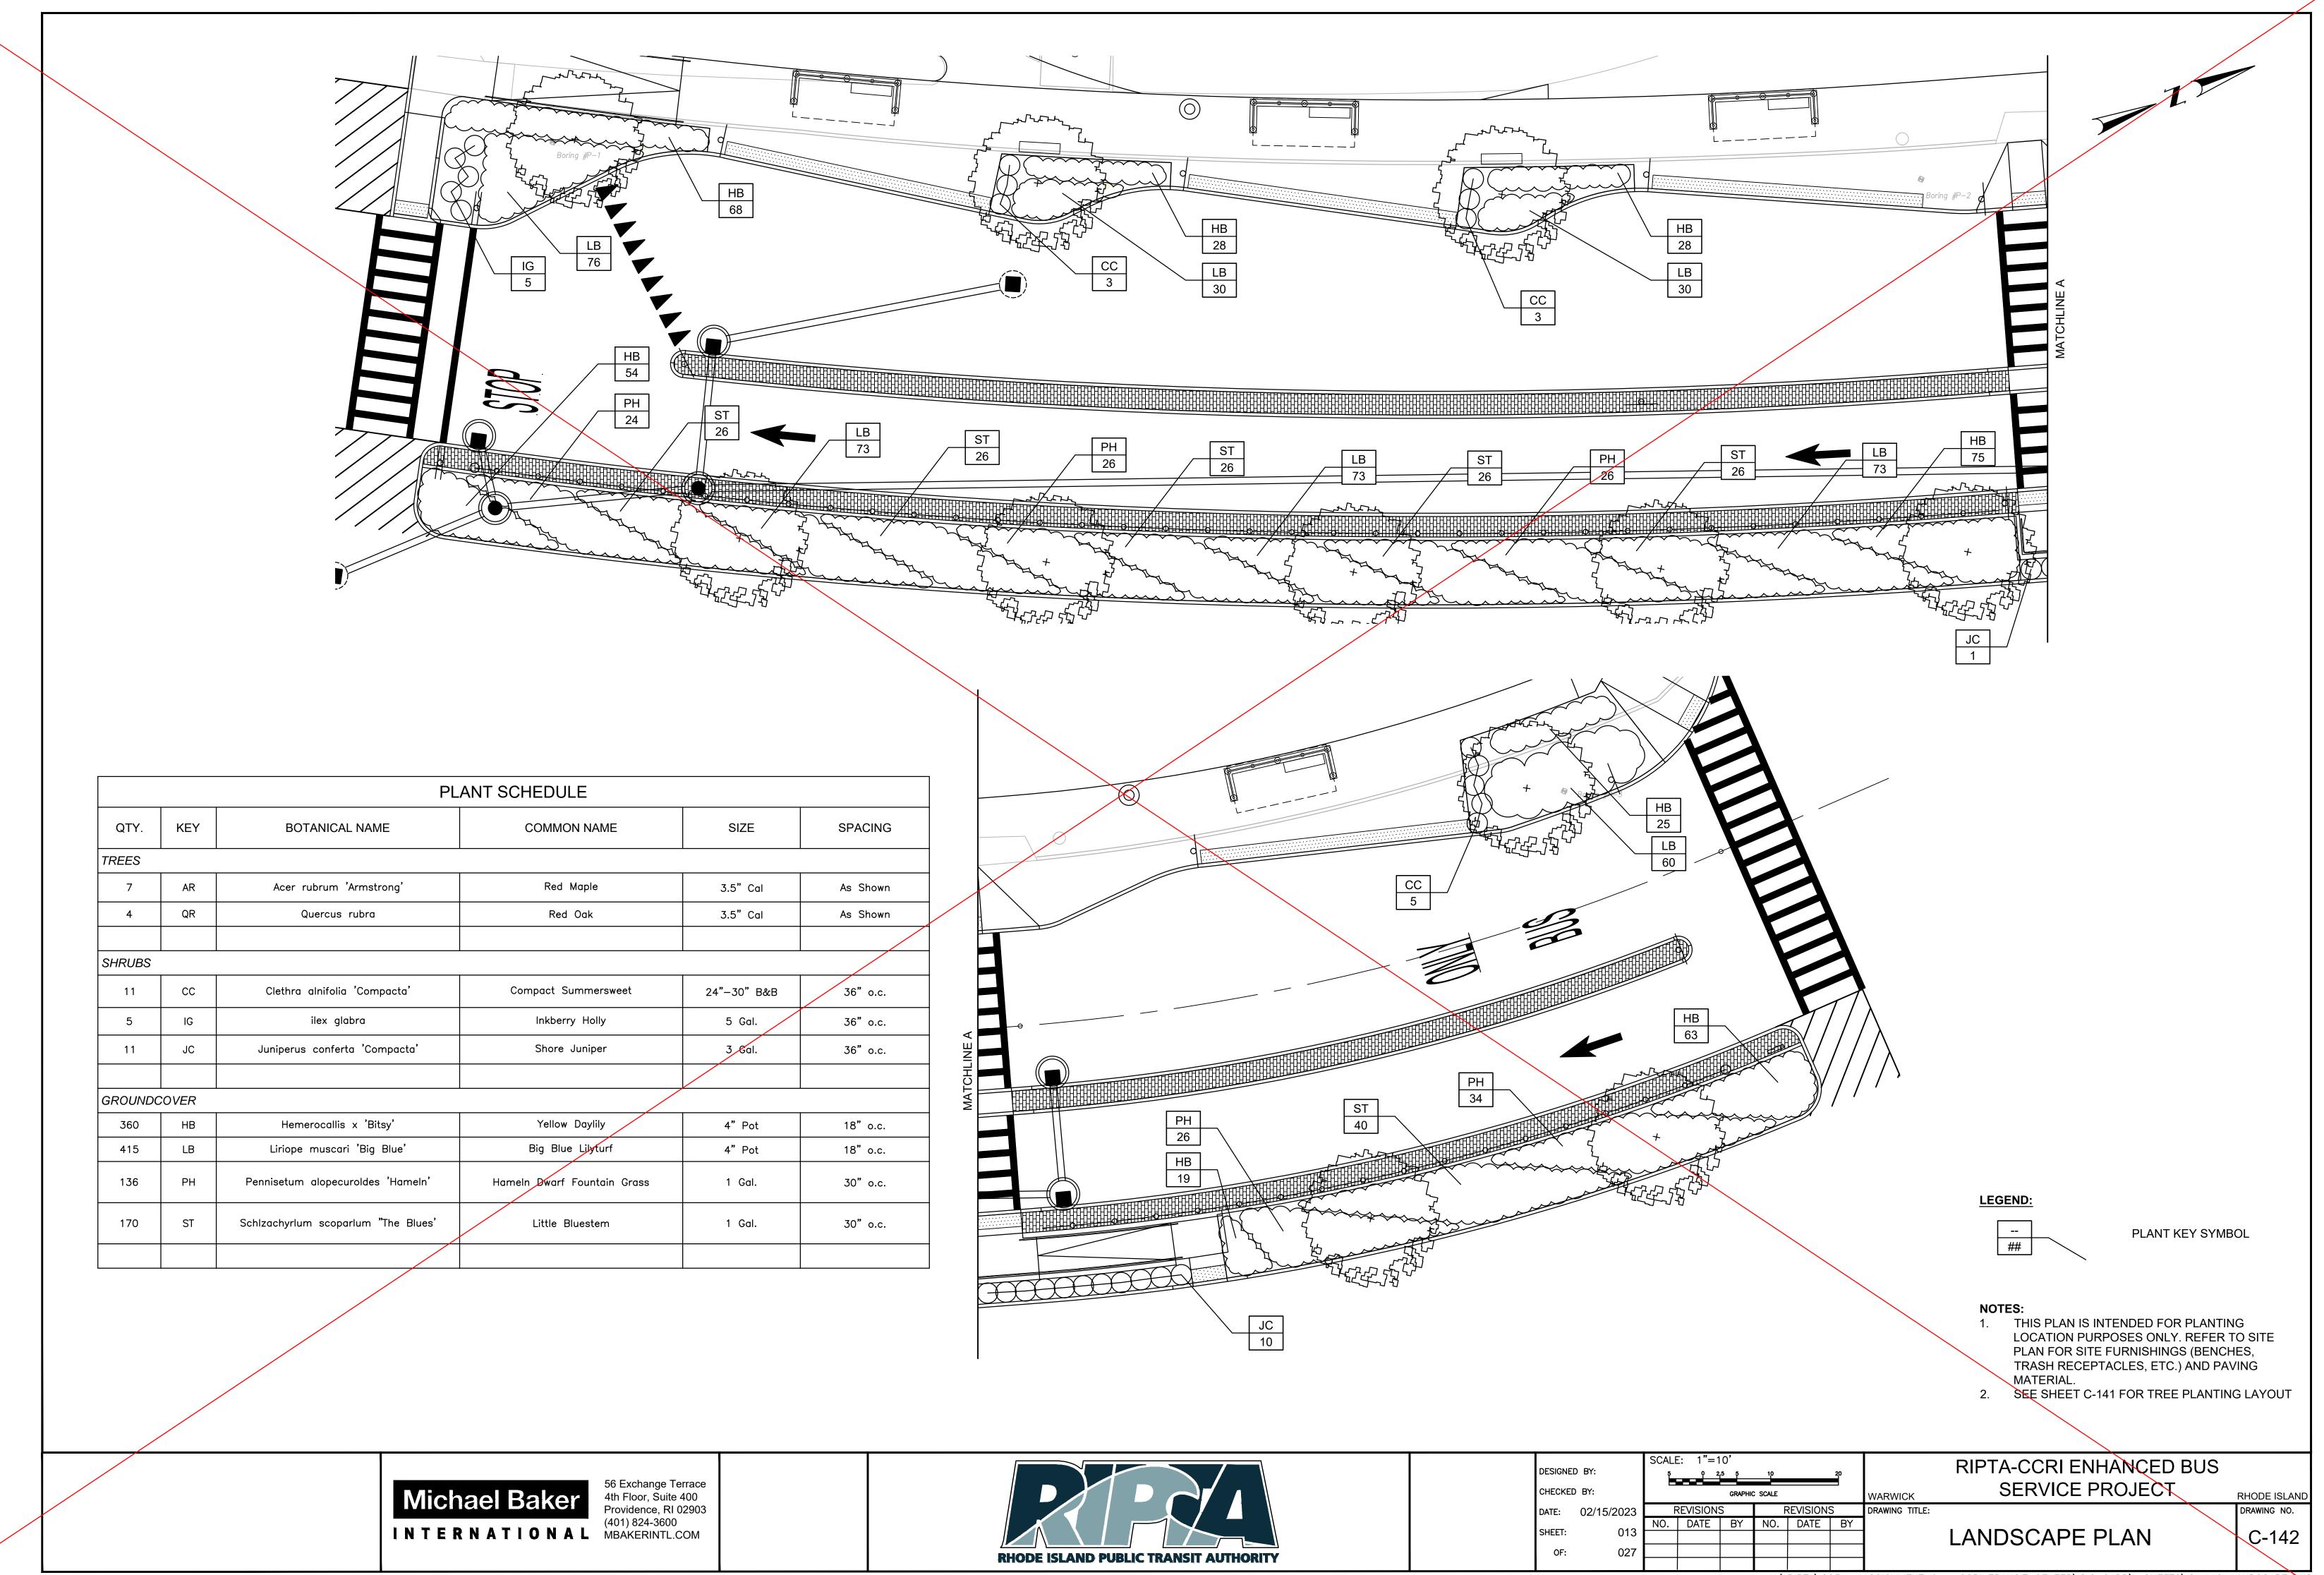
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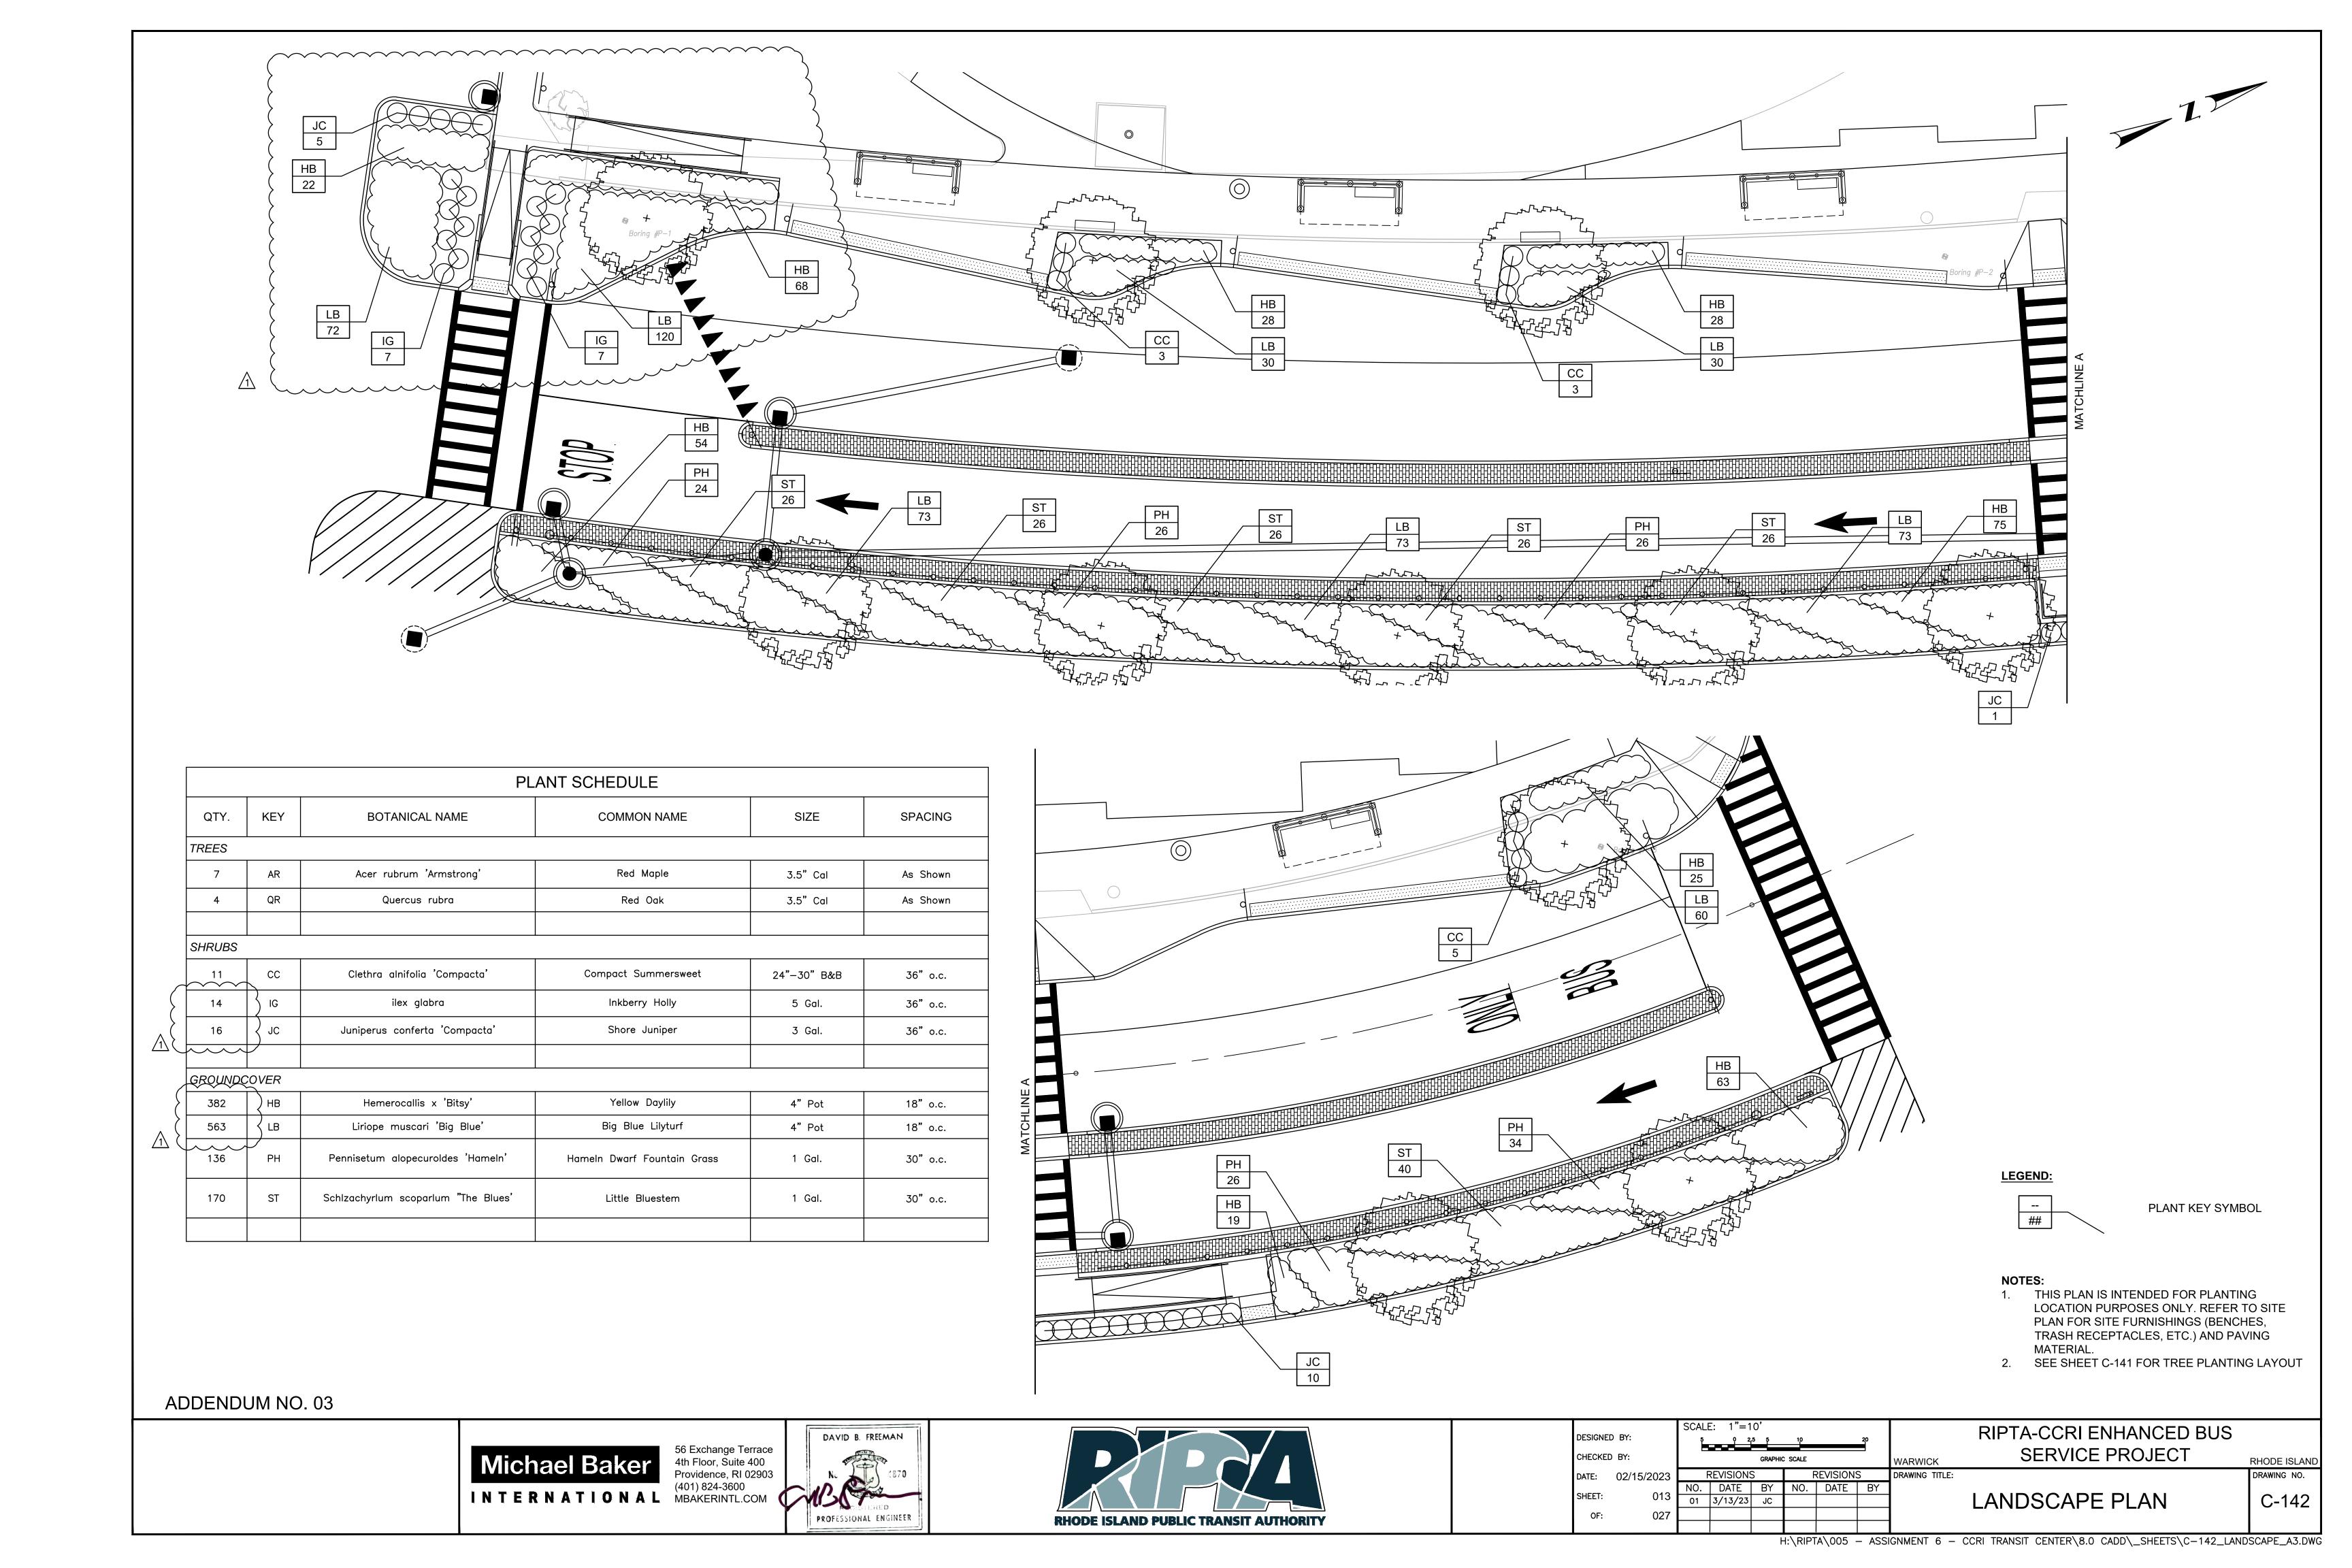
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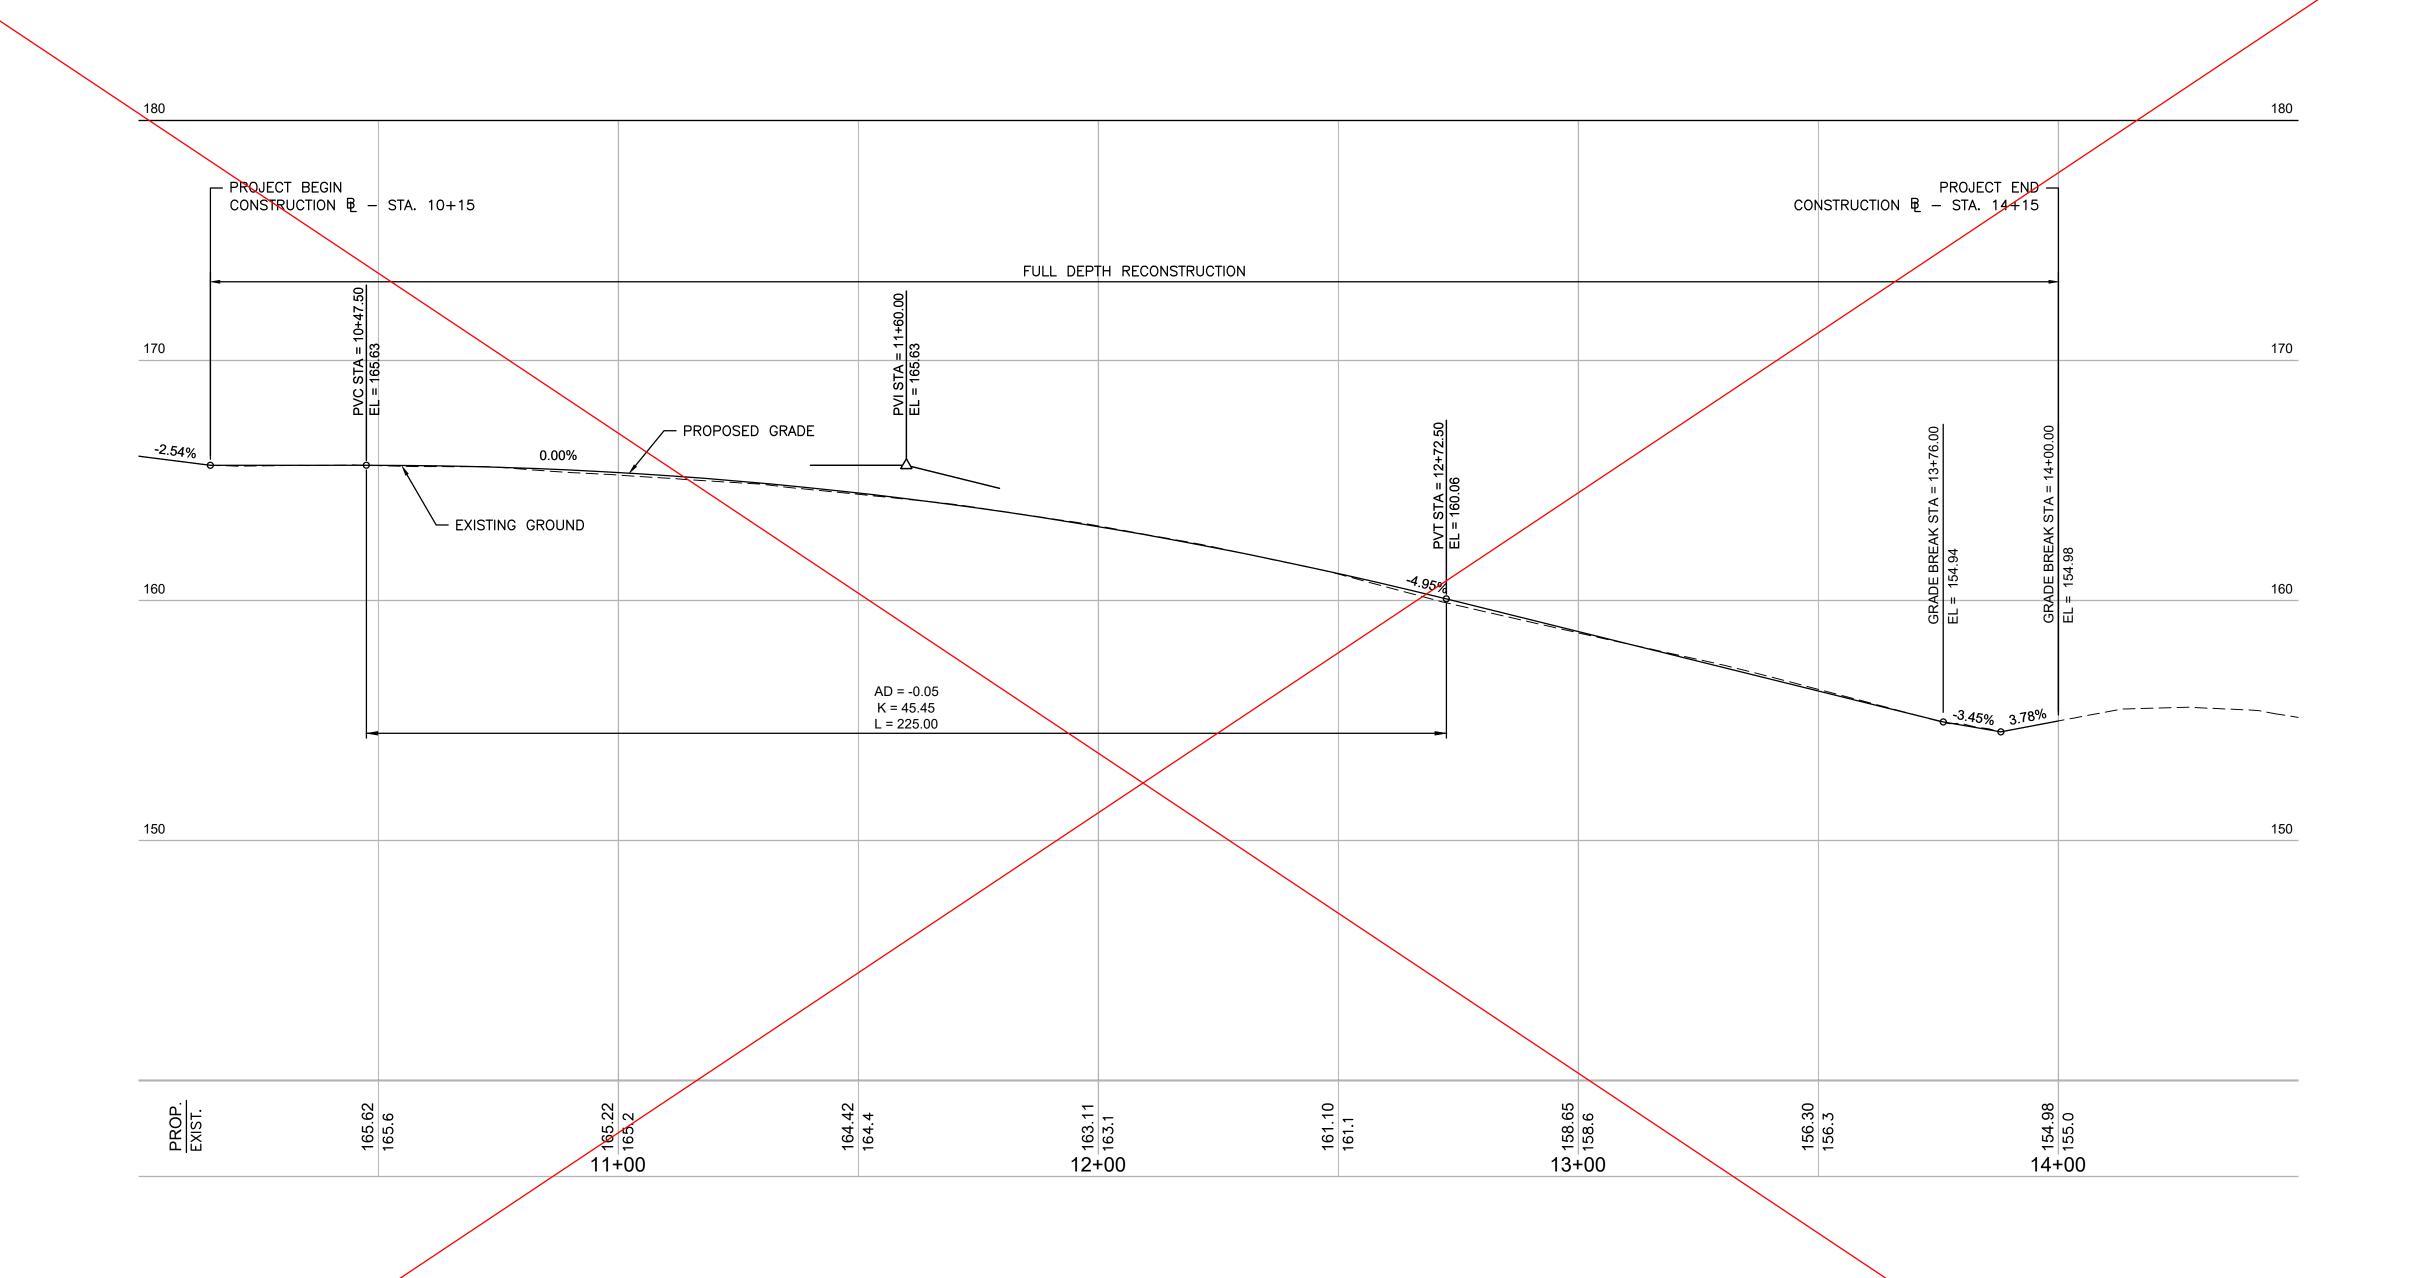






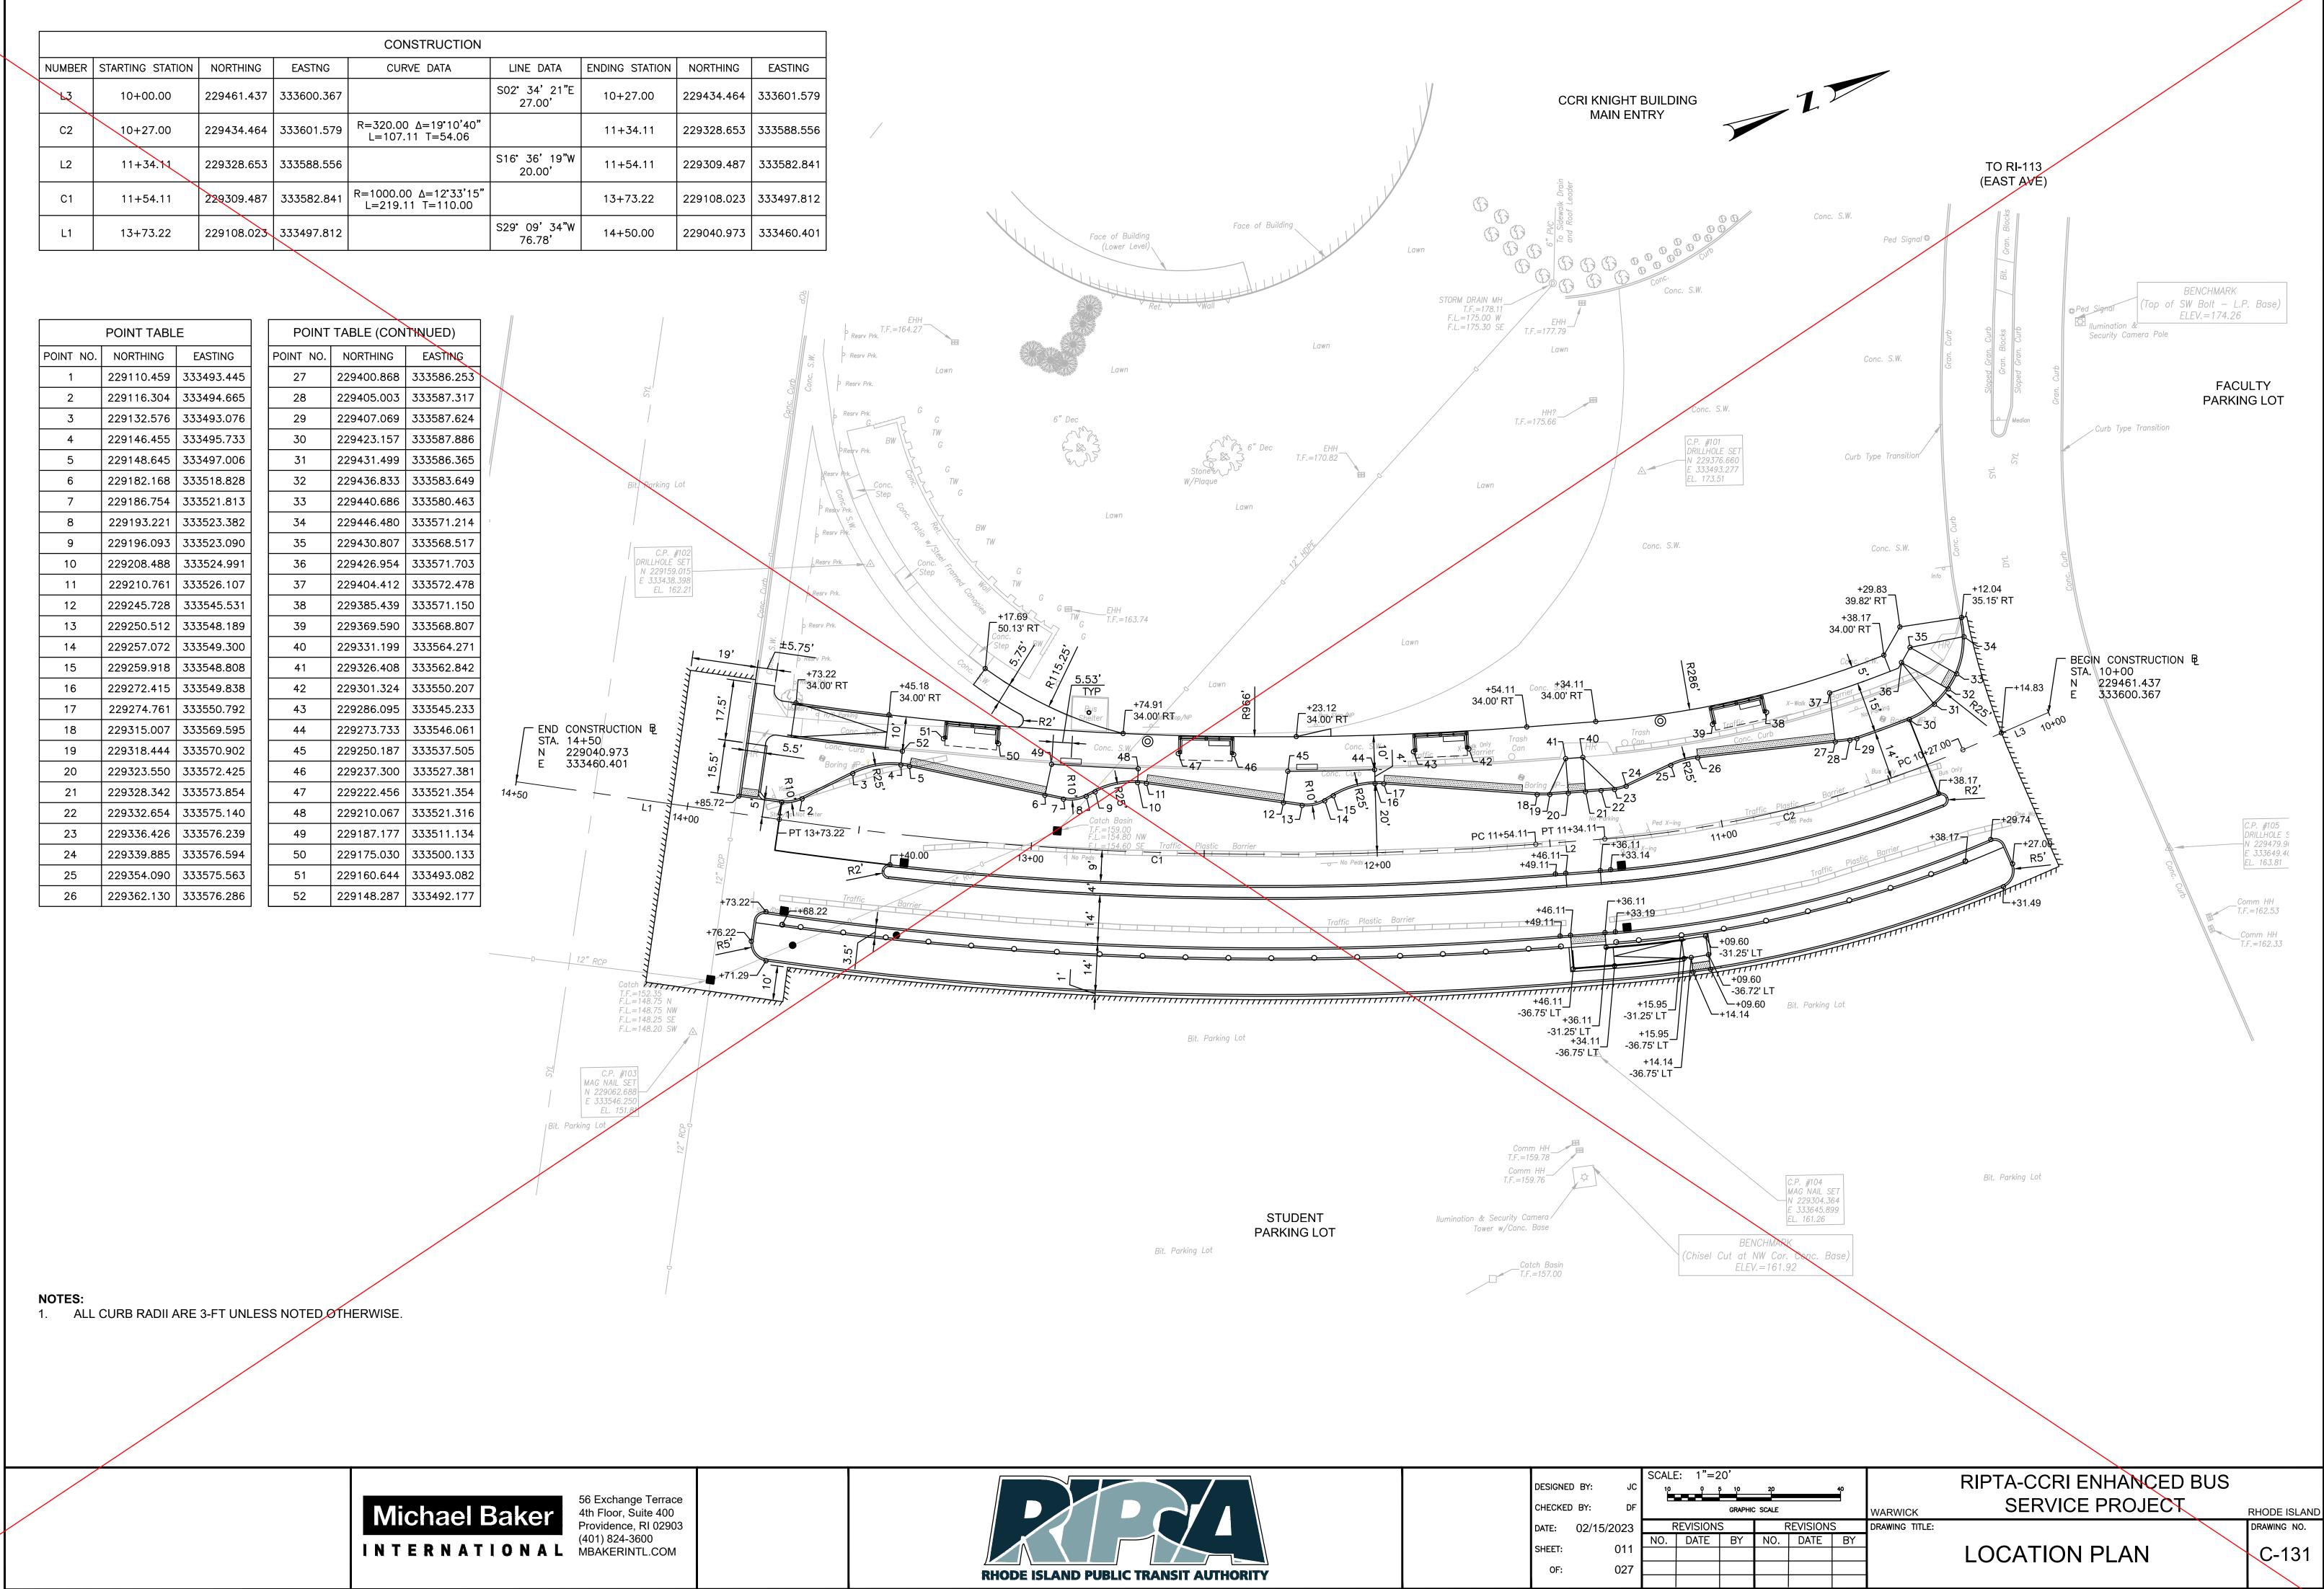

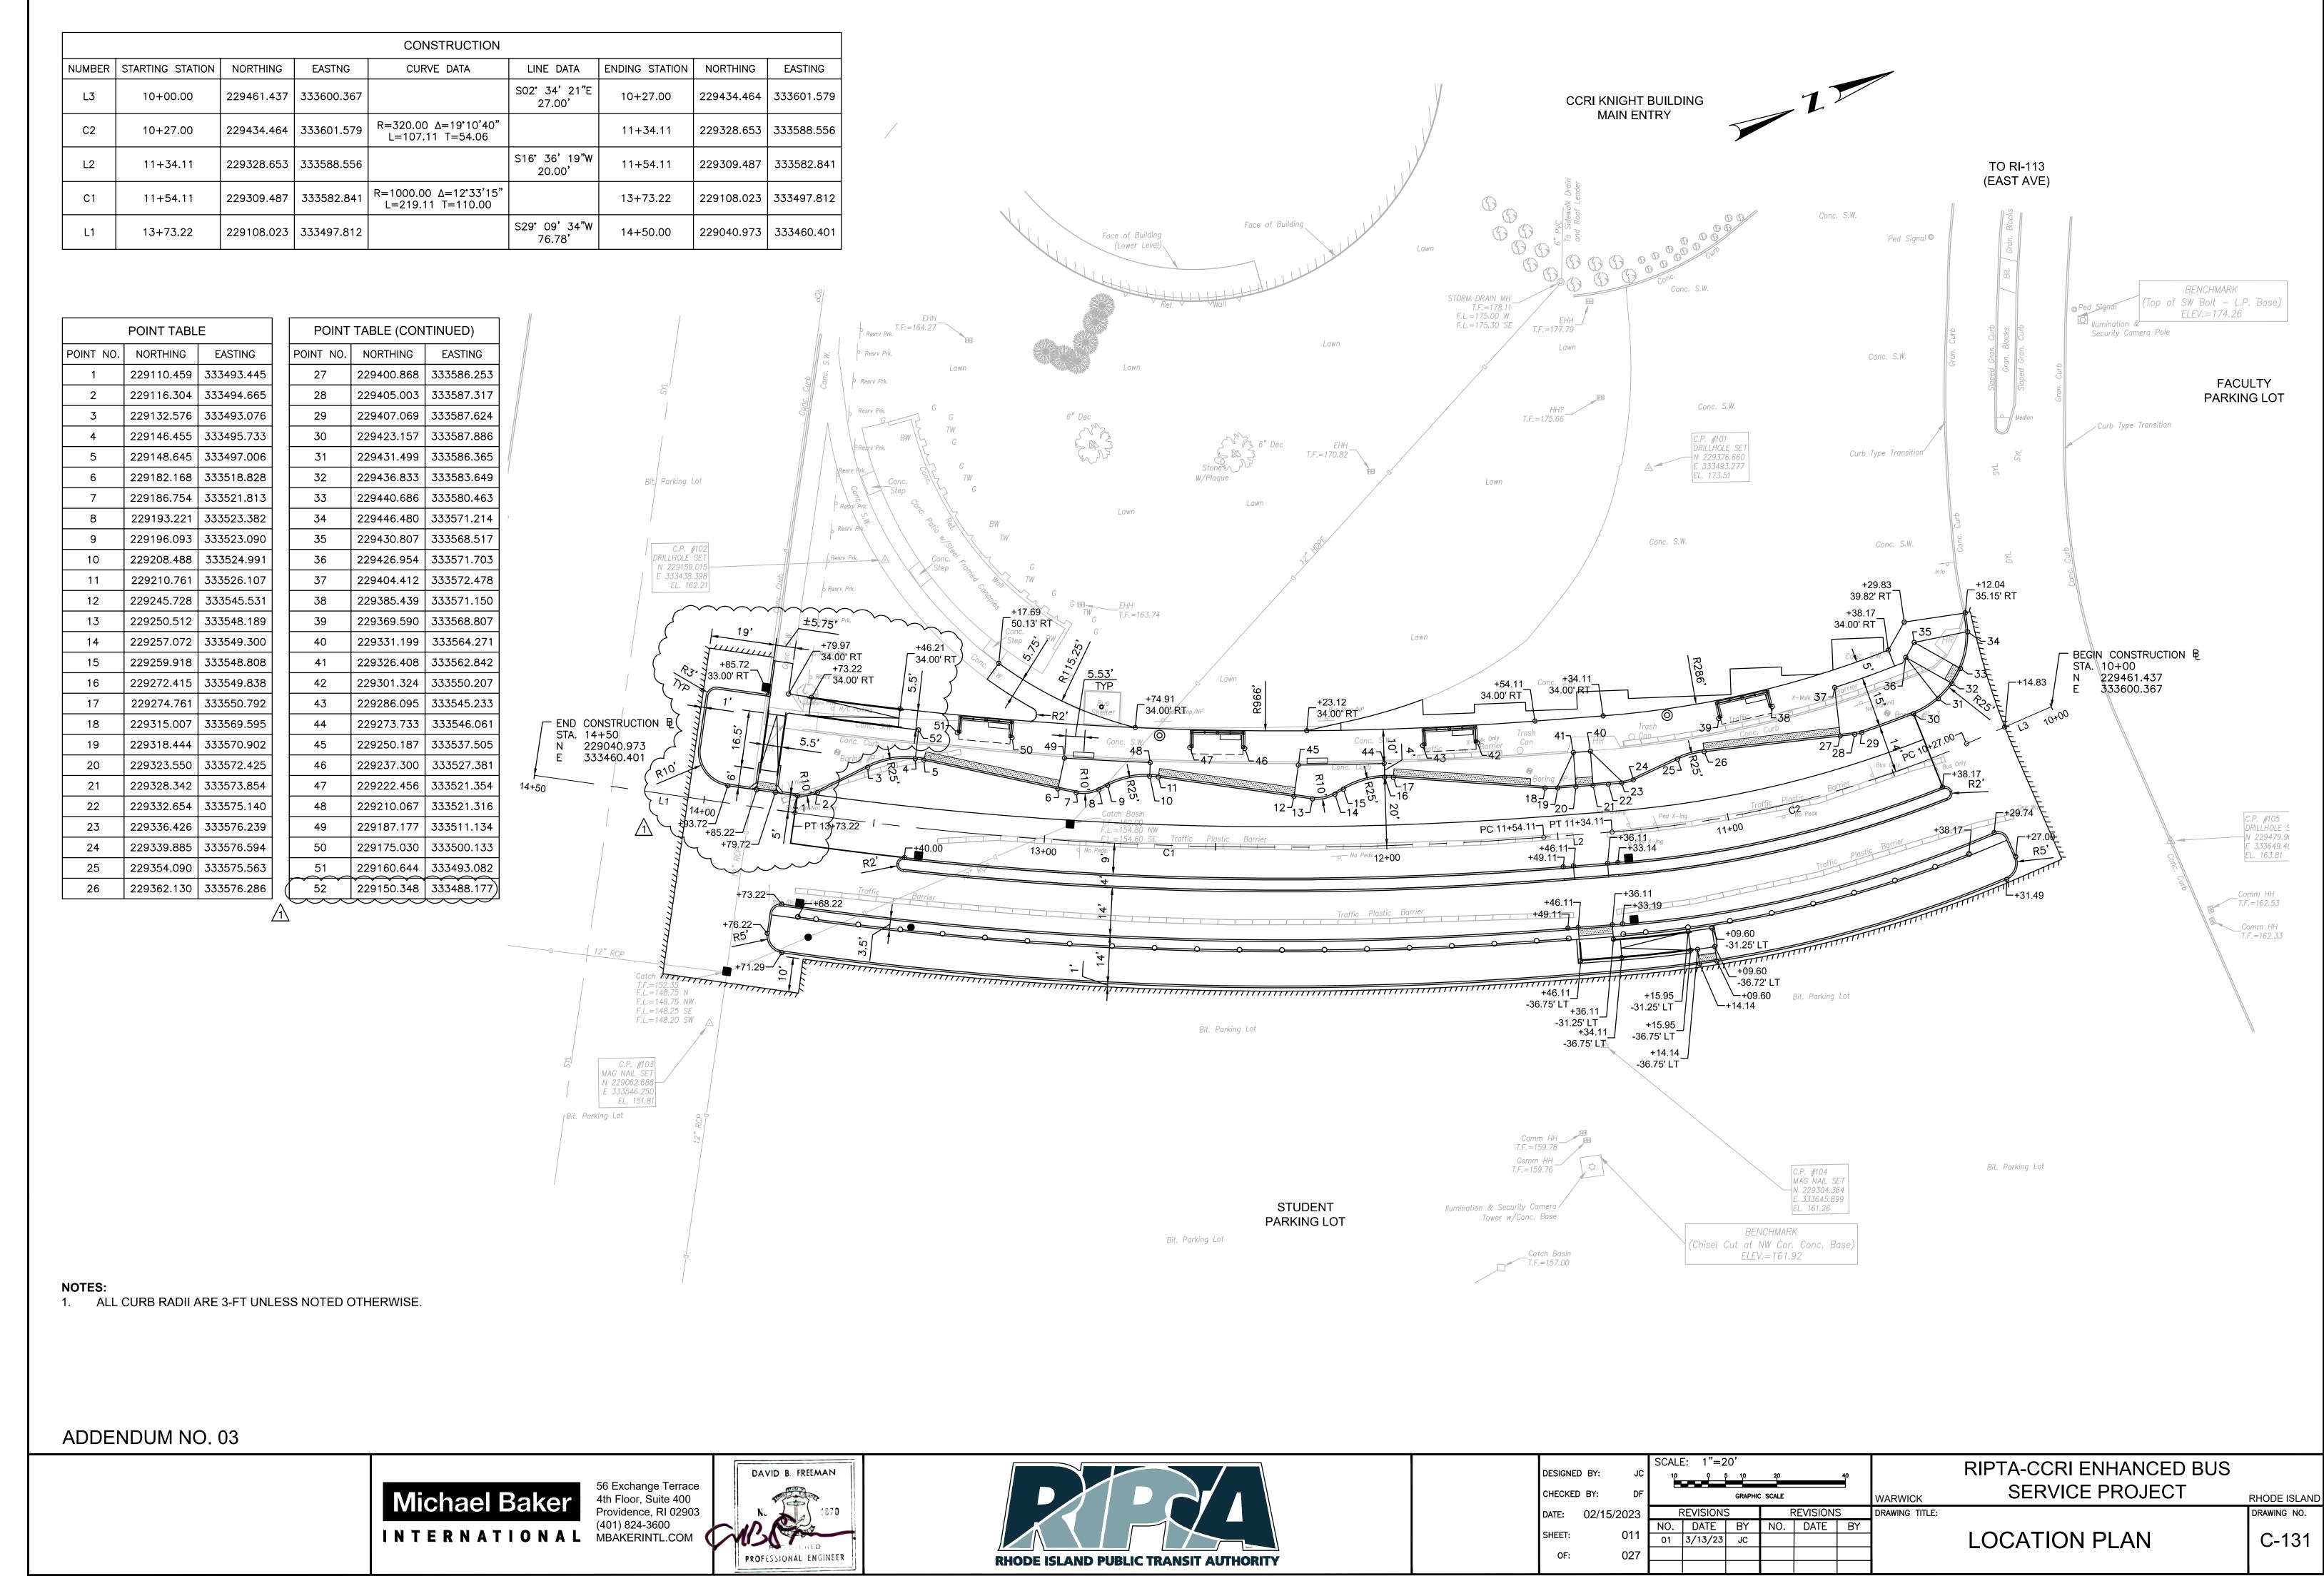

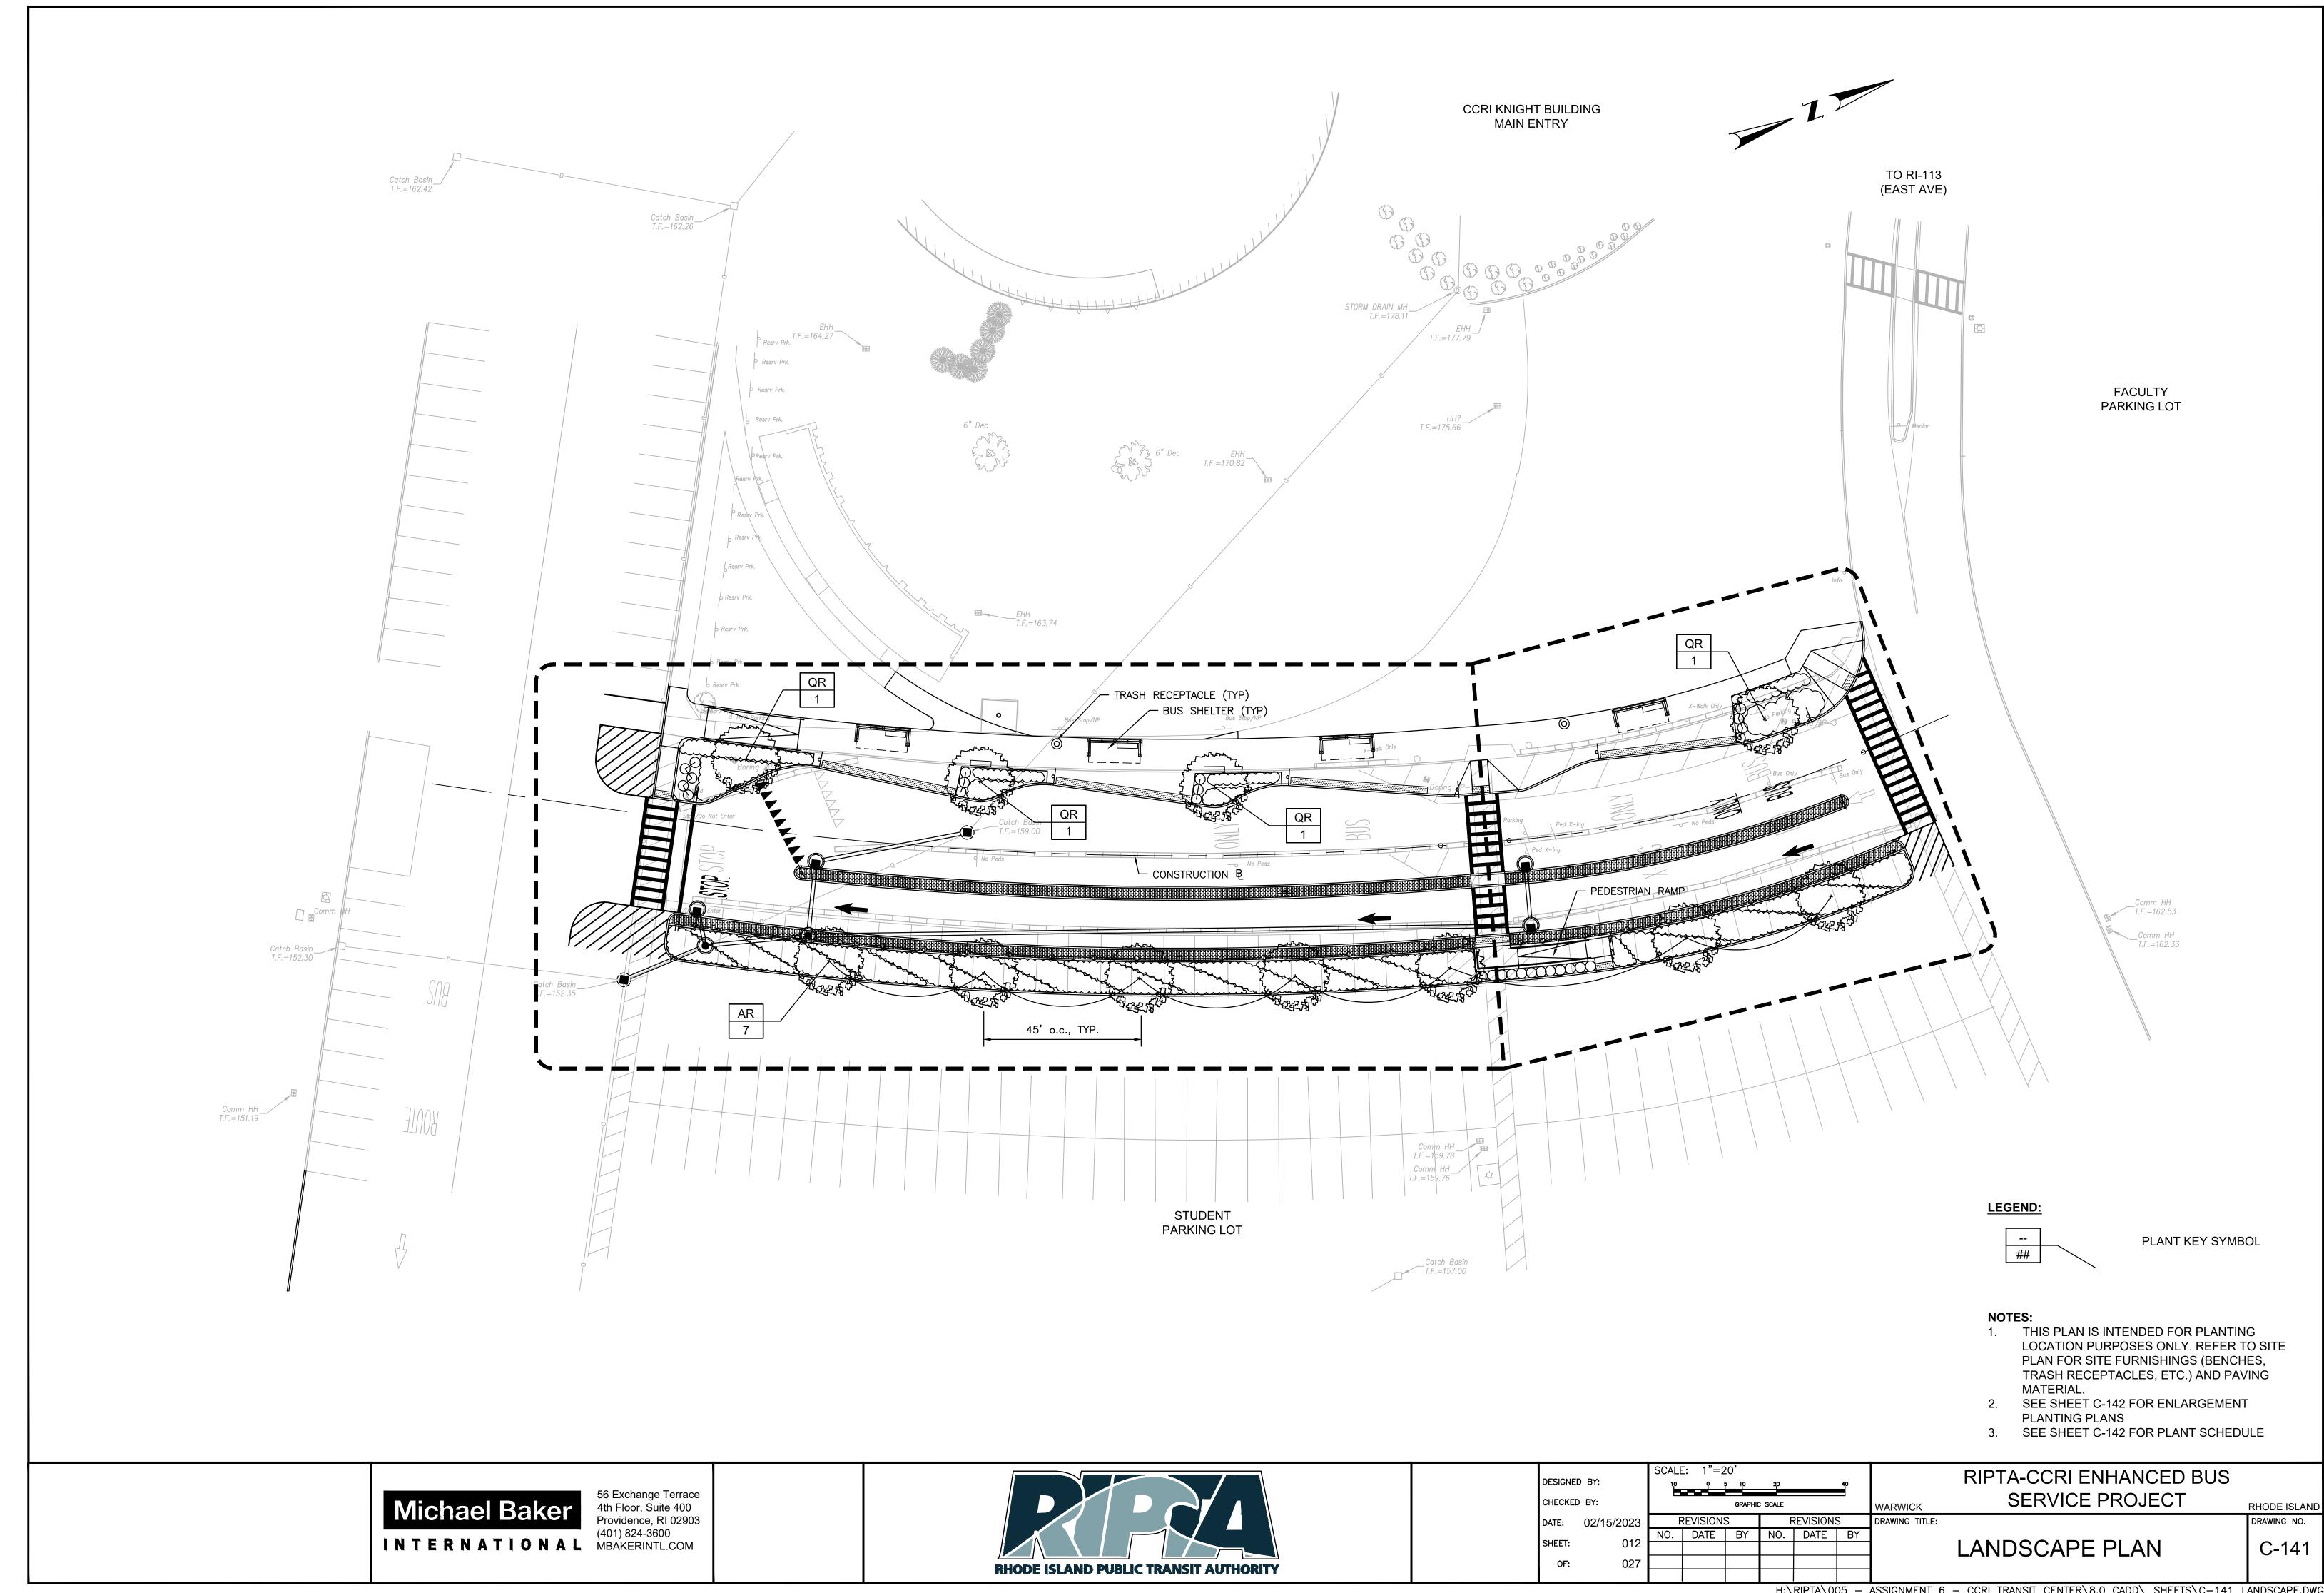


Michael Baker

Solution Suite 400
Providence, RI 02903
(401) 824-3600
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ADDENDUM NO. 03

Michael Baker


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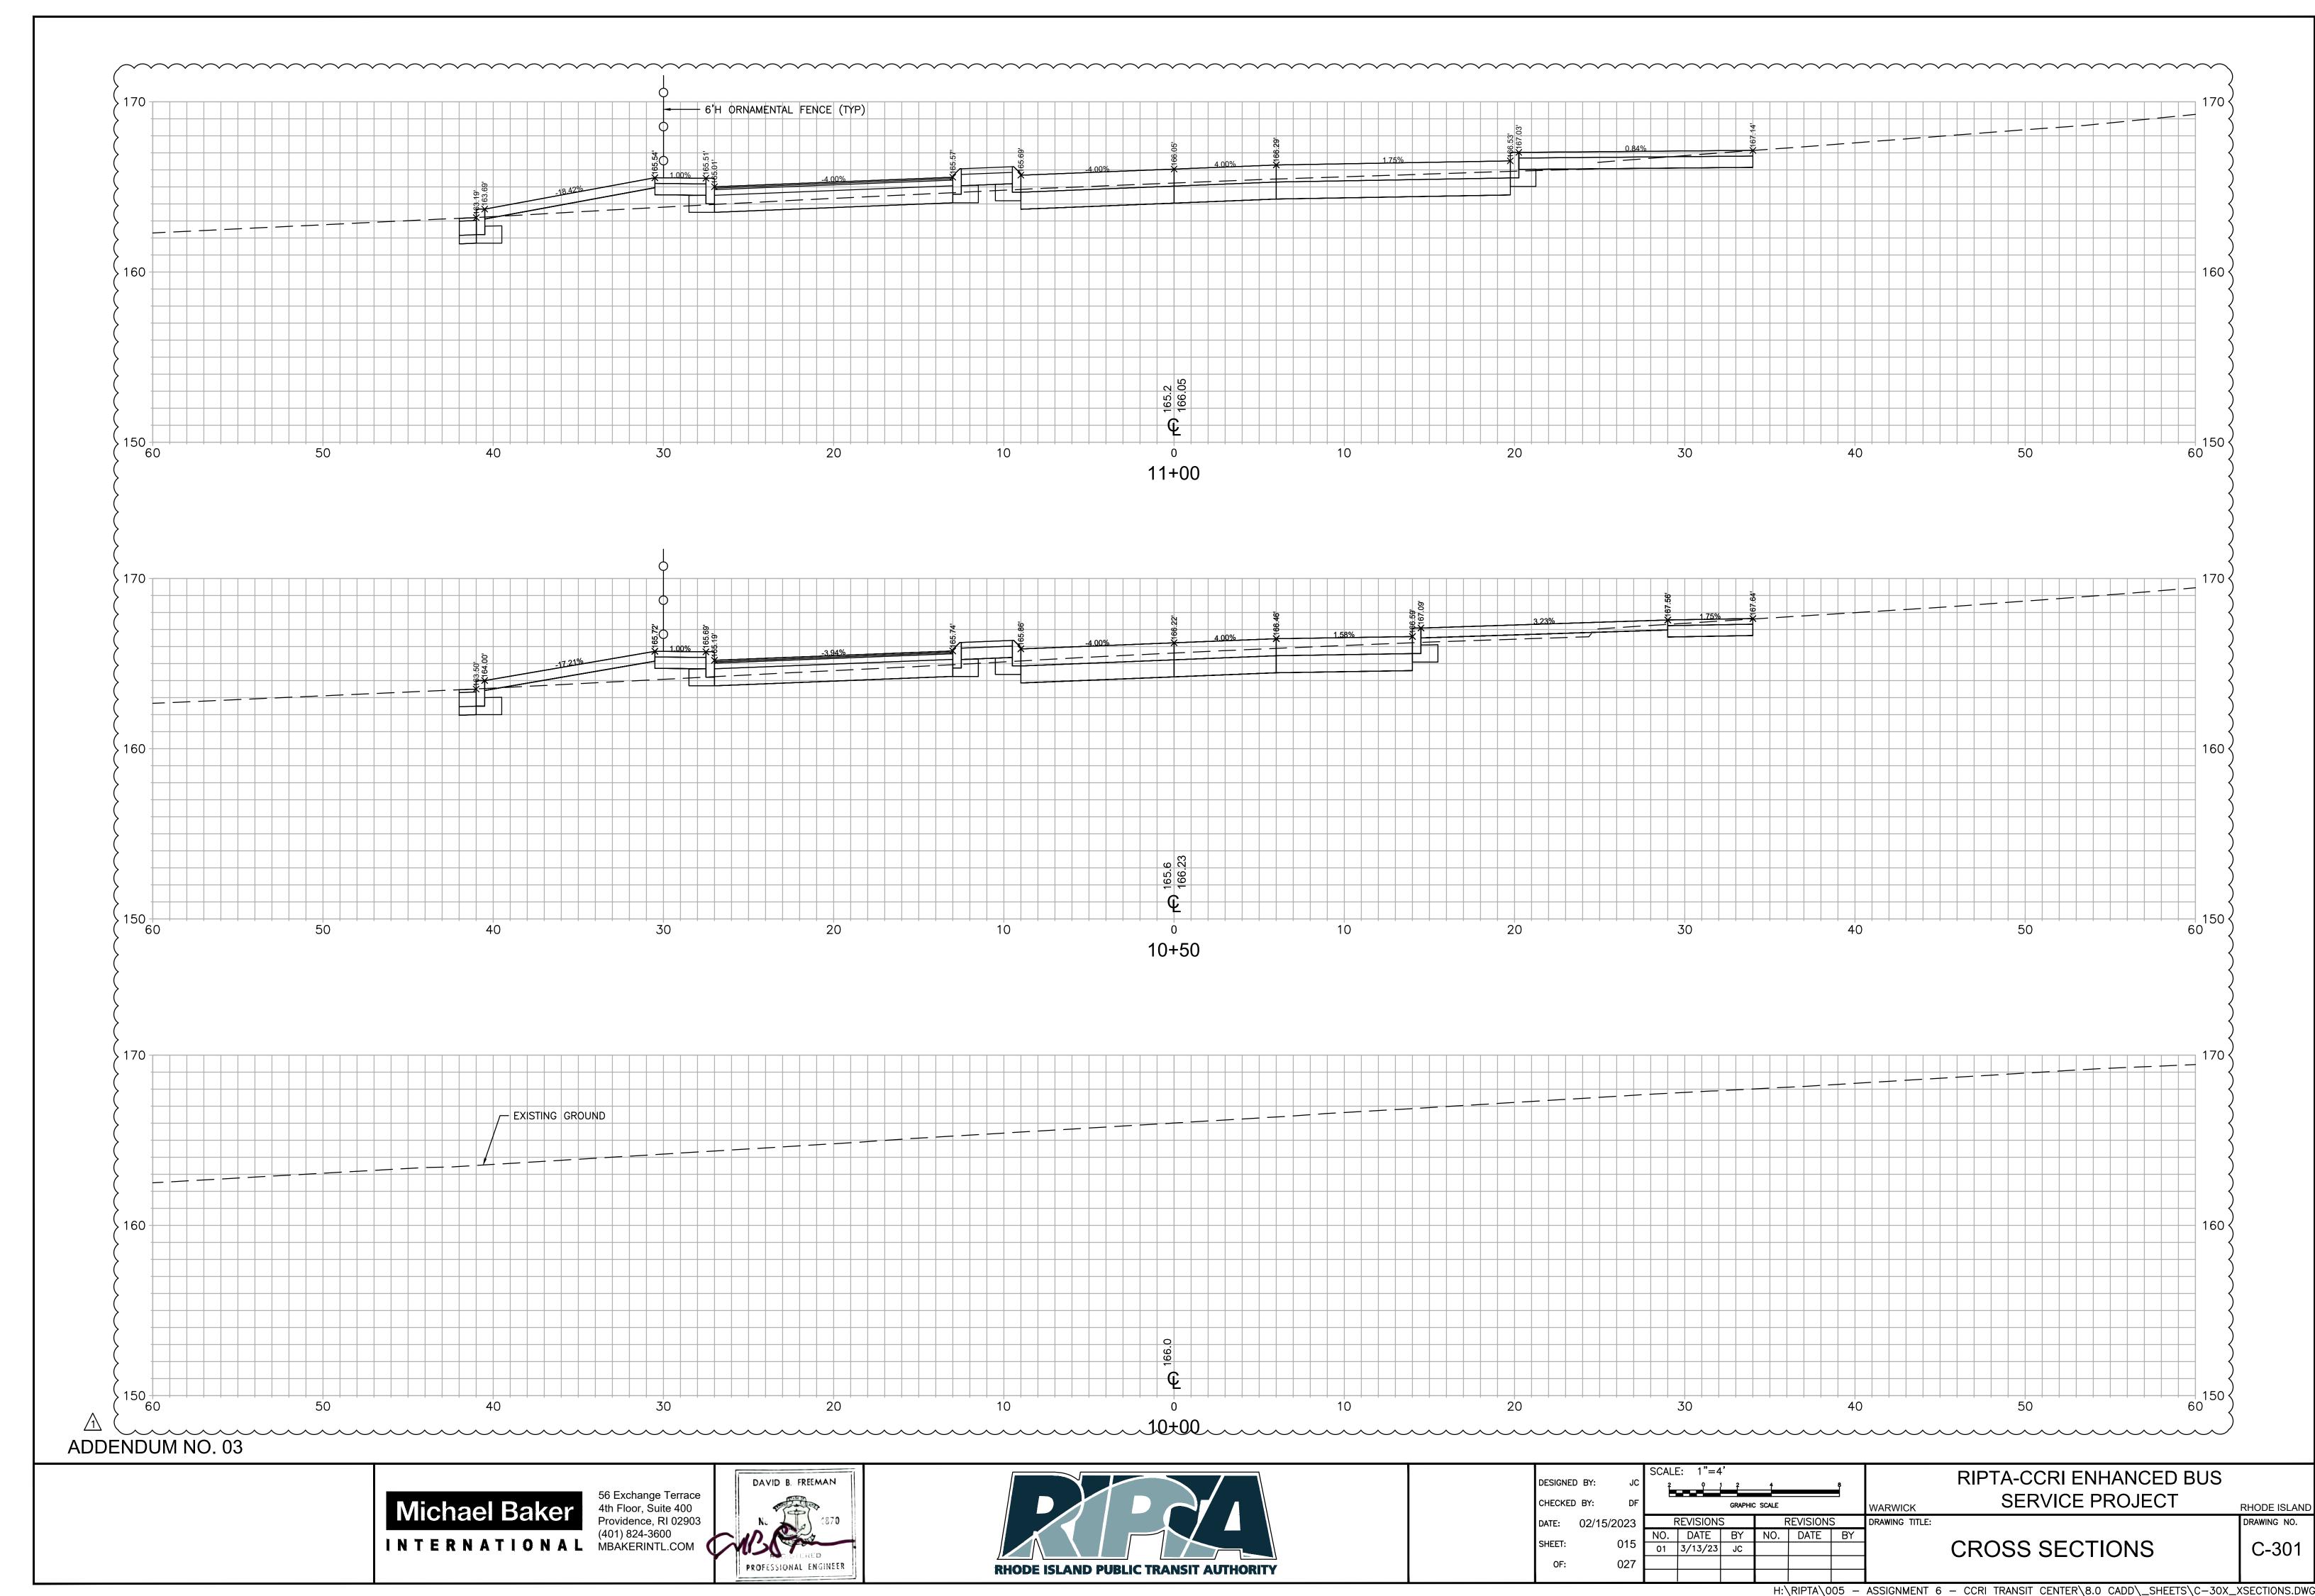
56 Exchange Terrace
4th Floor, Suite 400
Providence, RI 02903
(401) 824-3600
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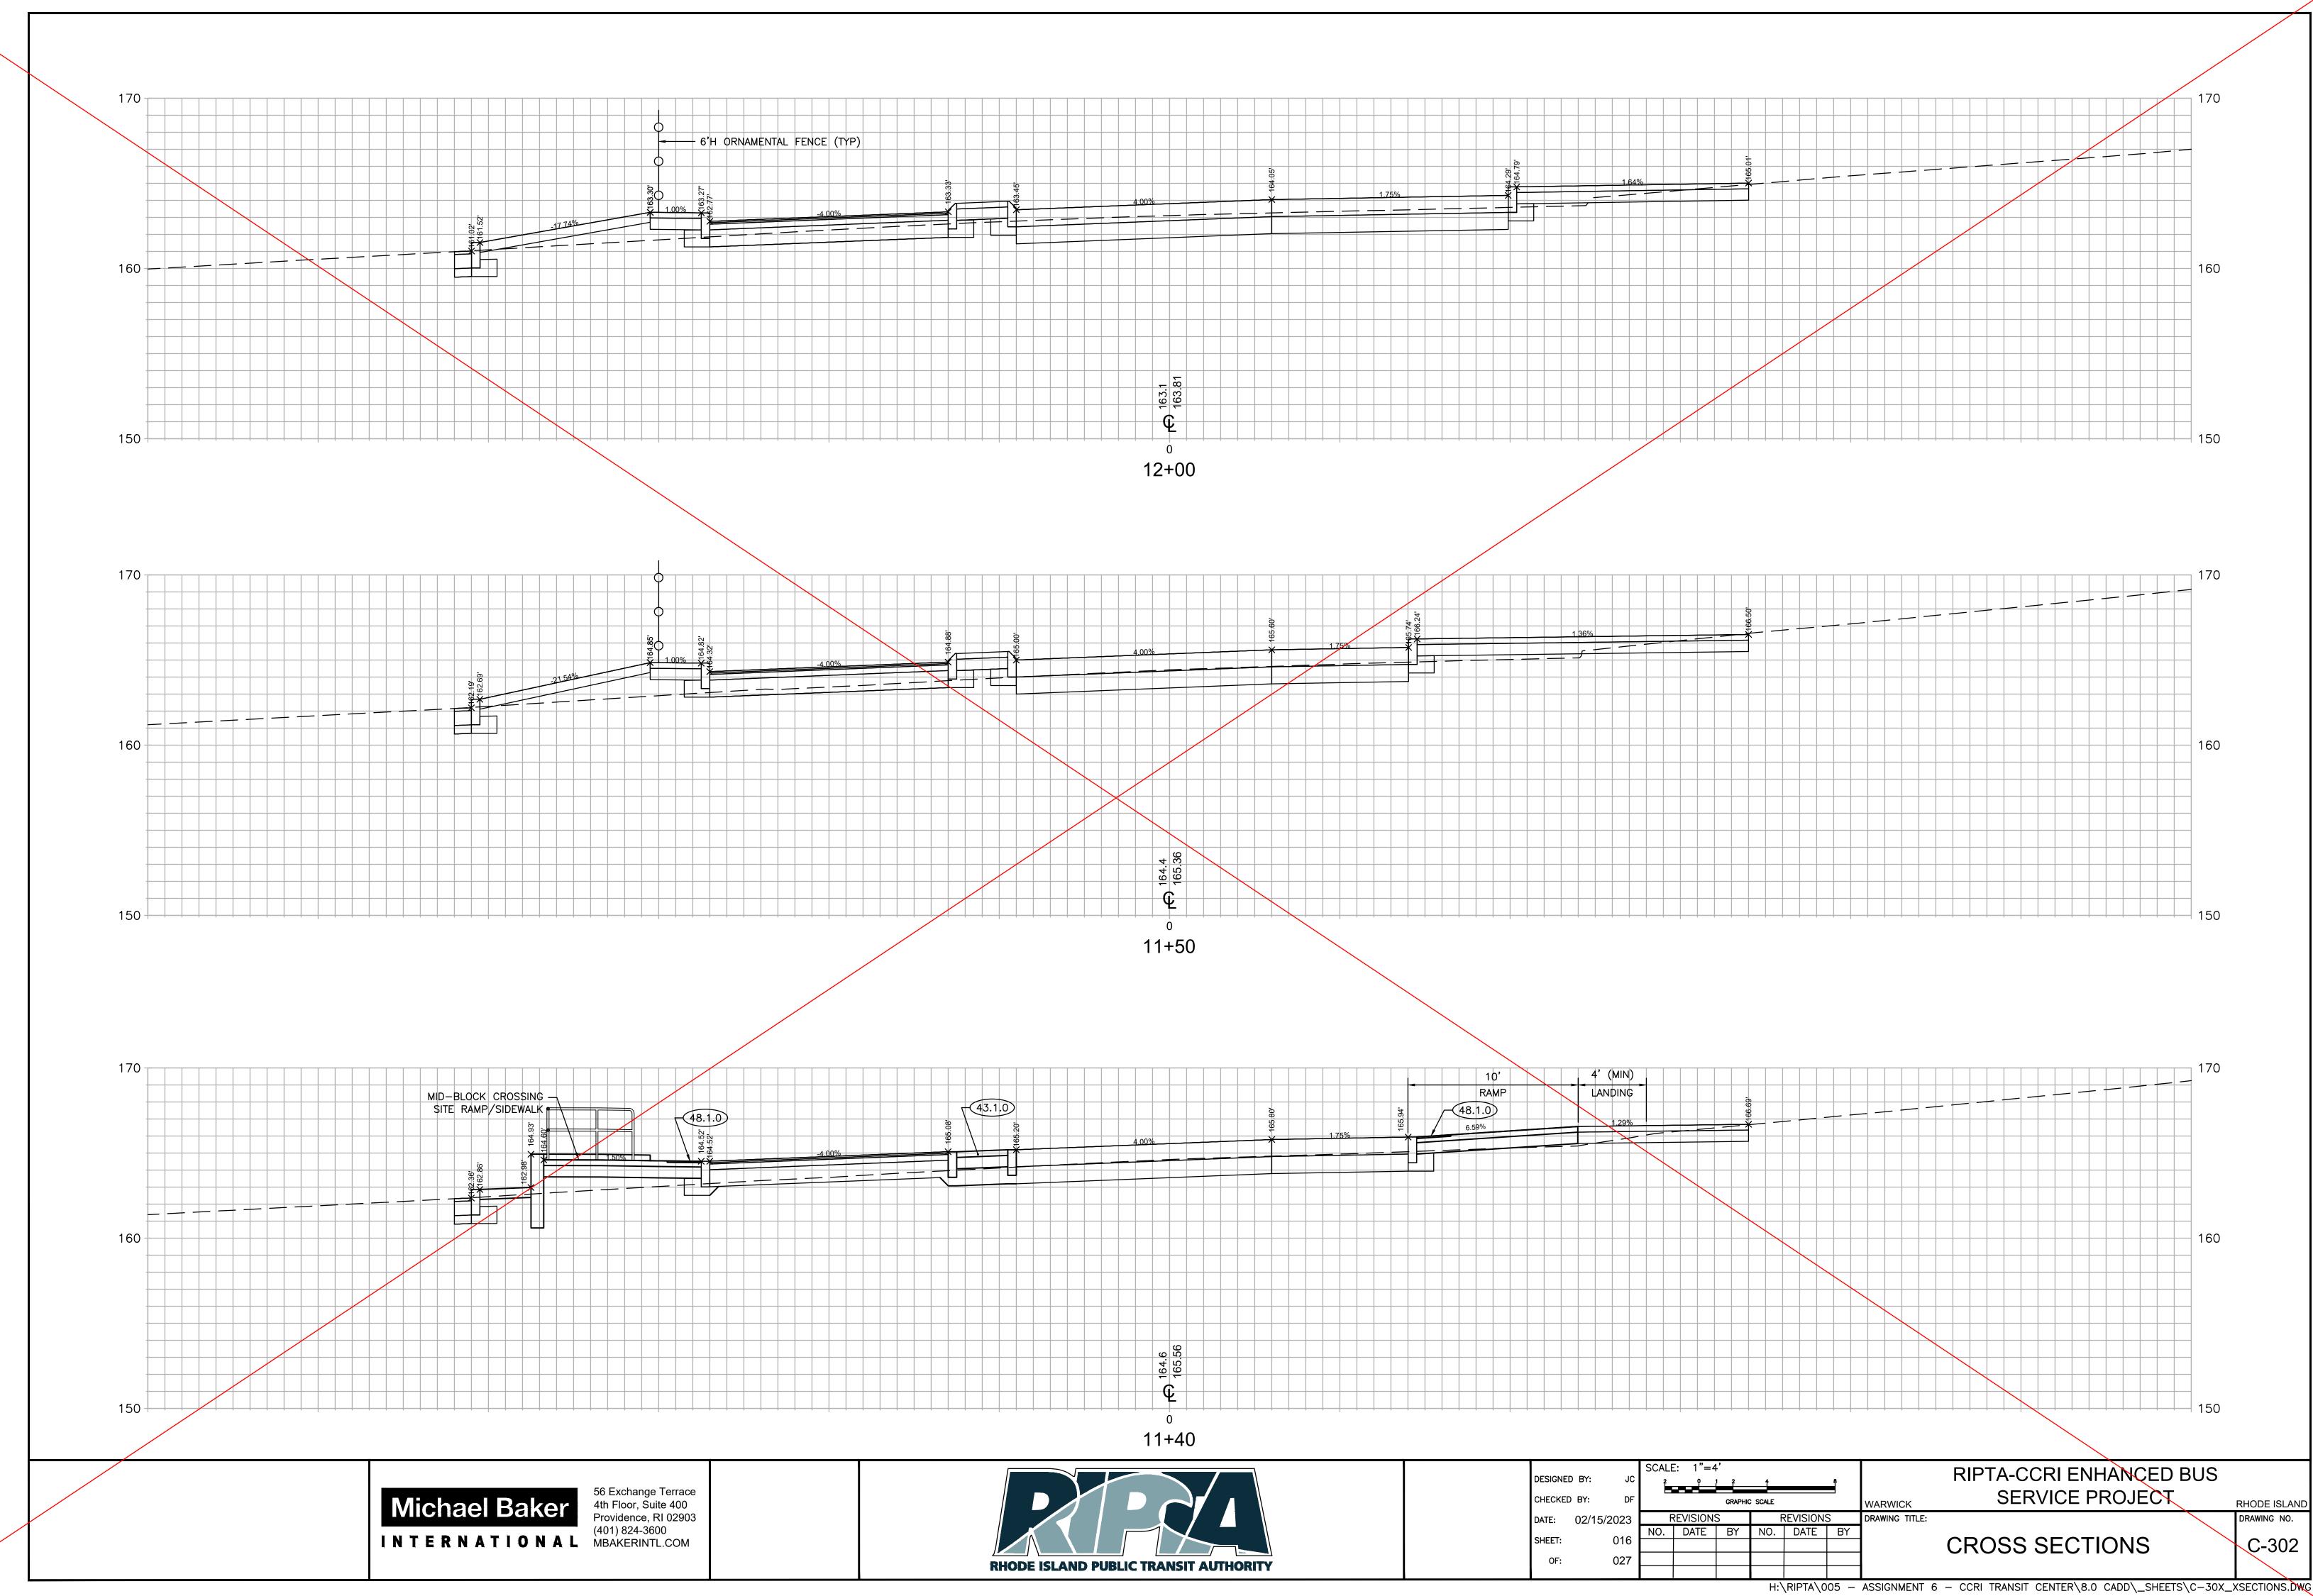


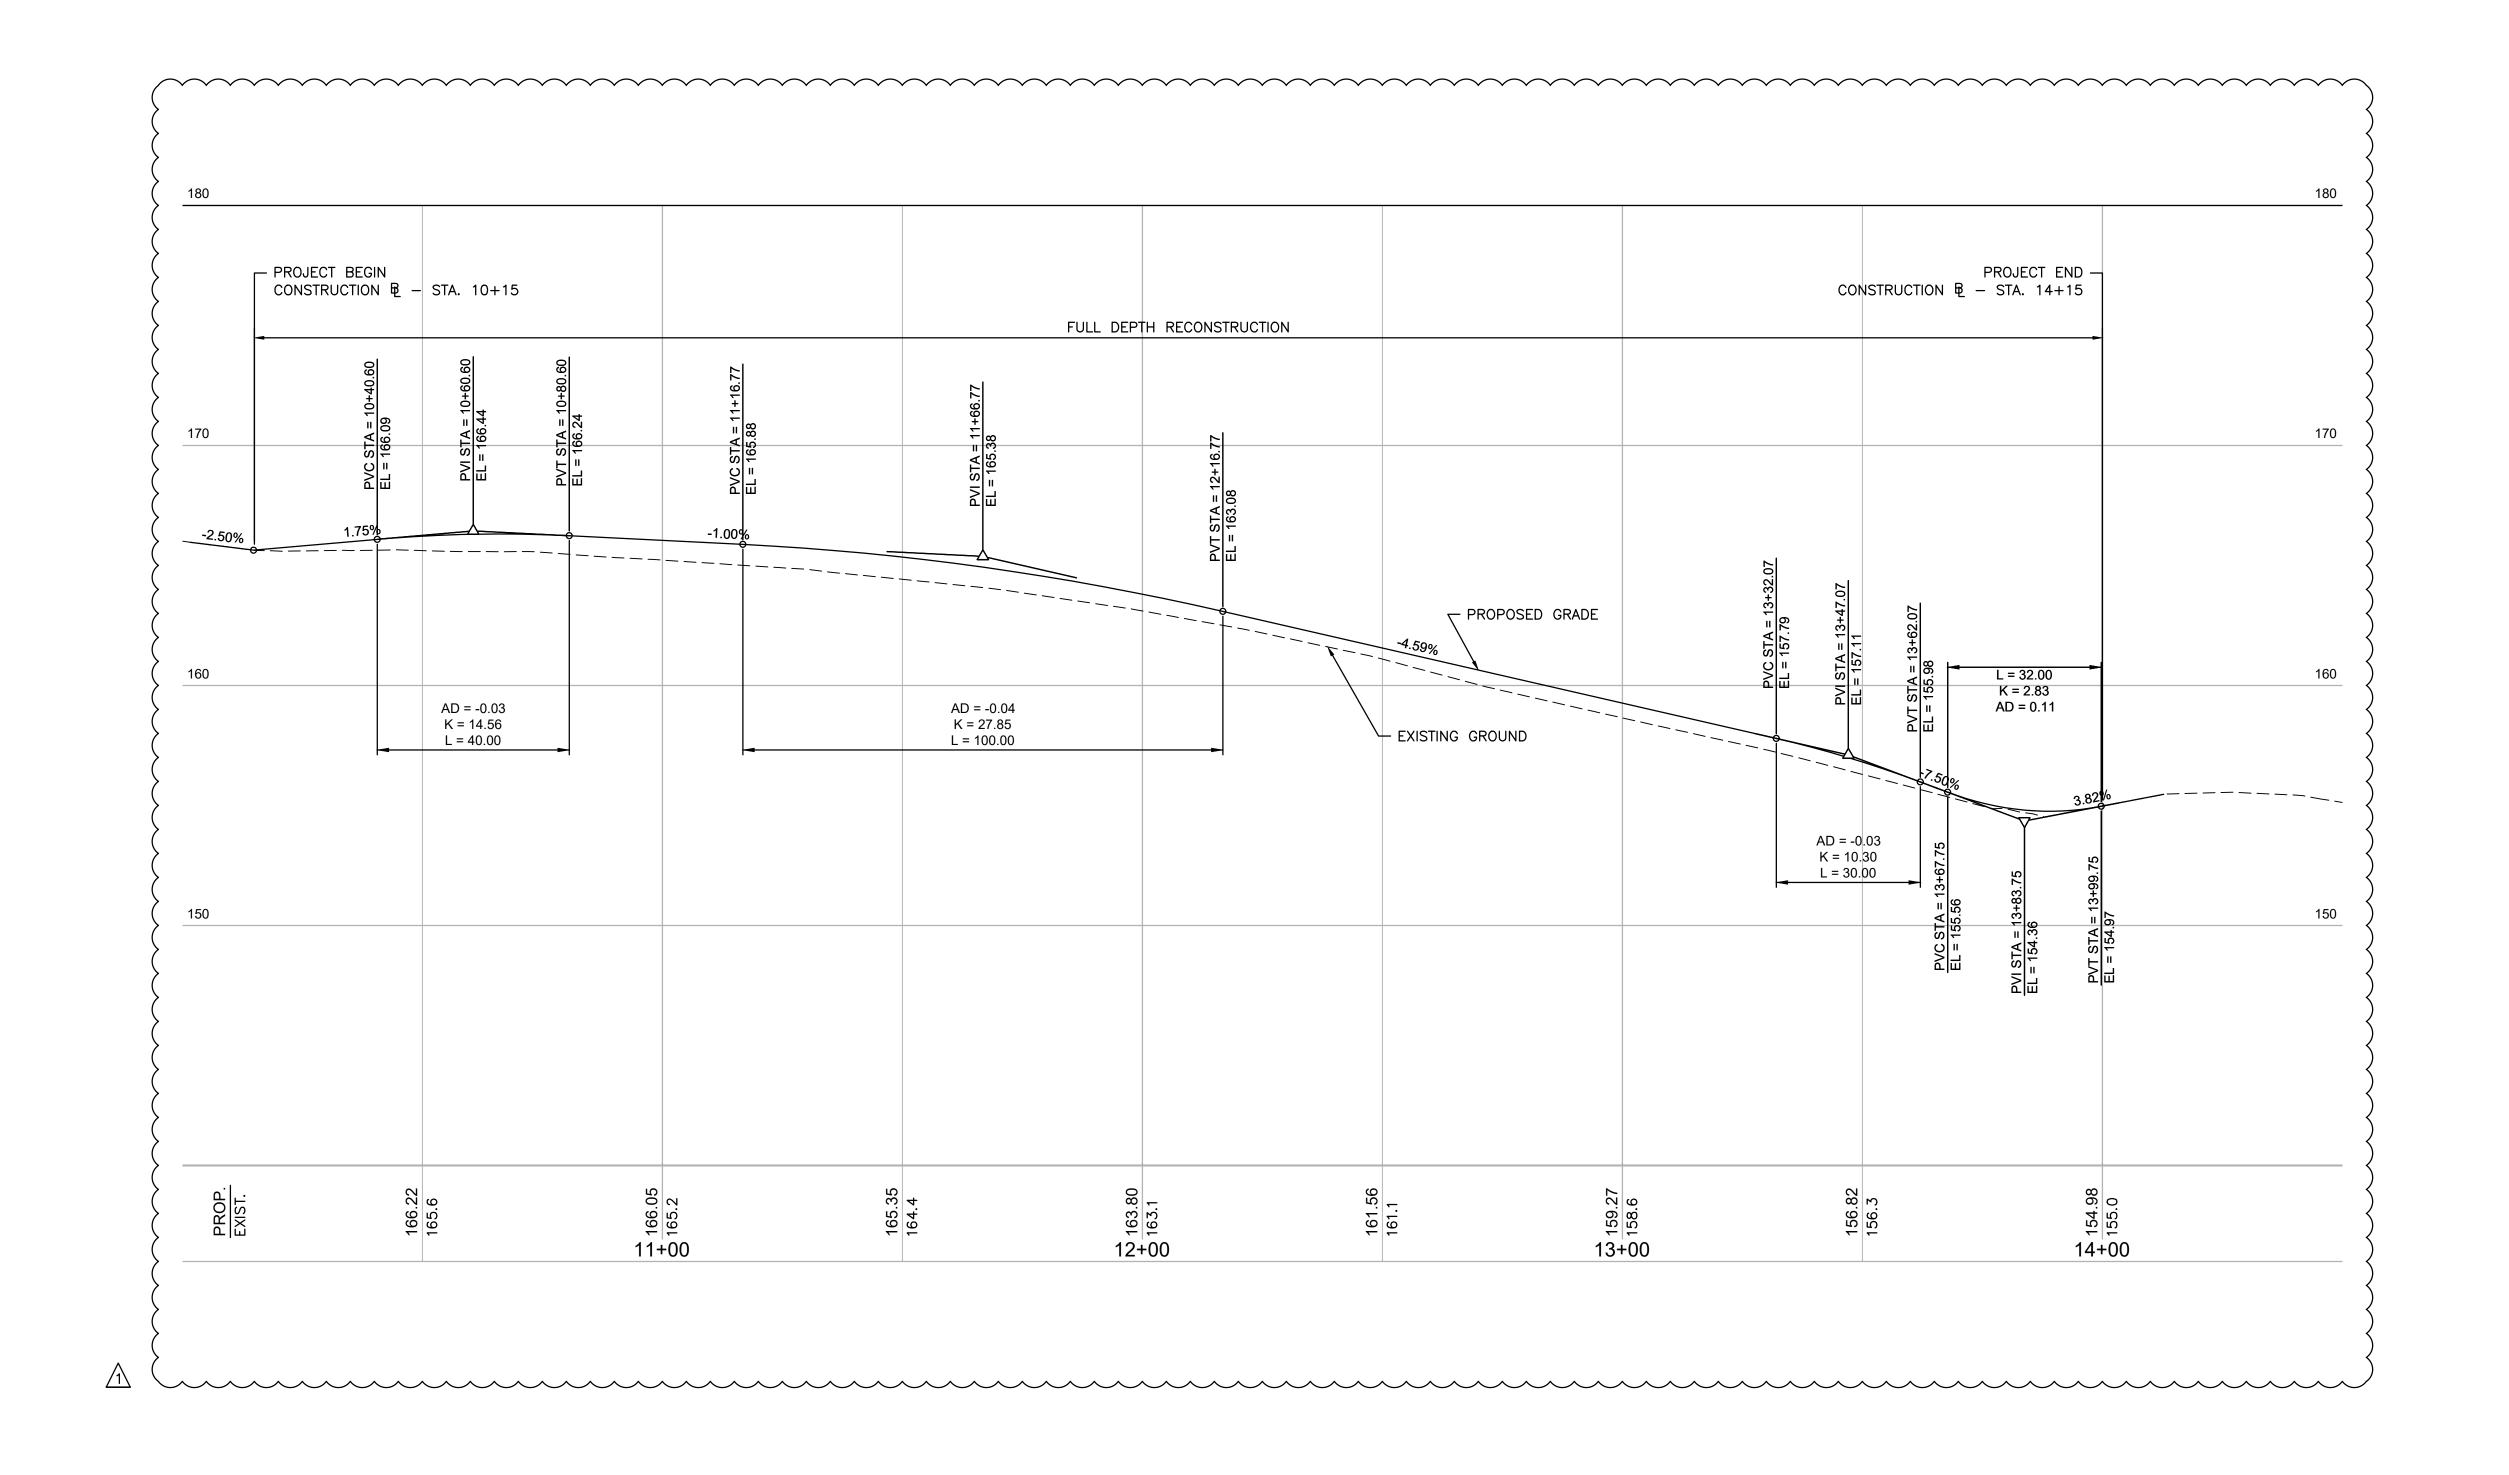



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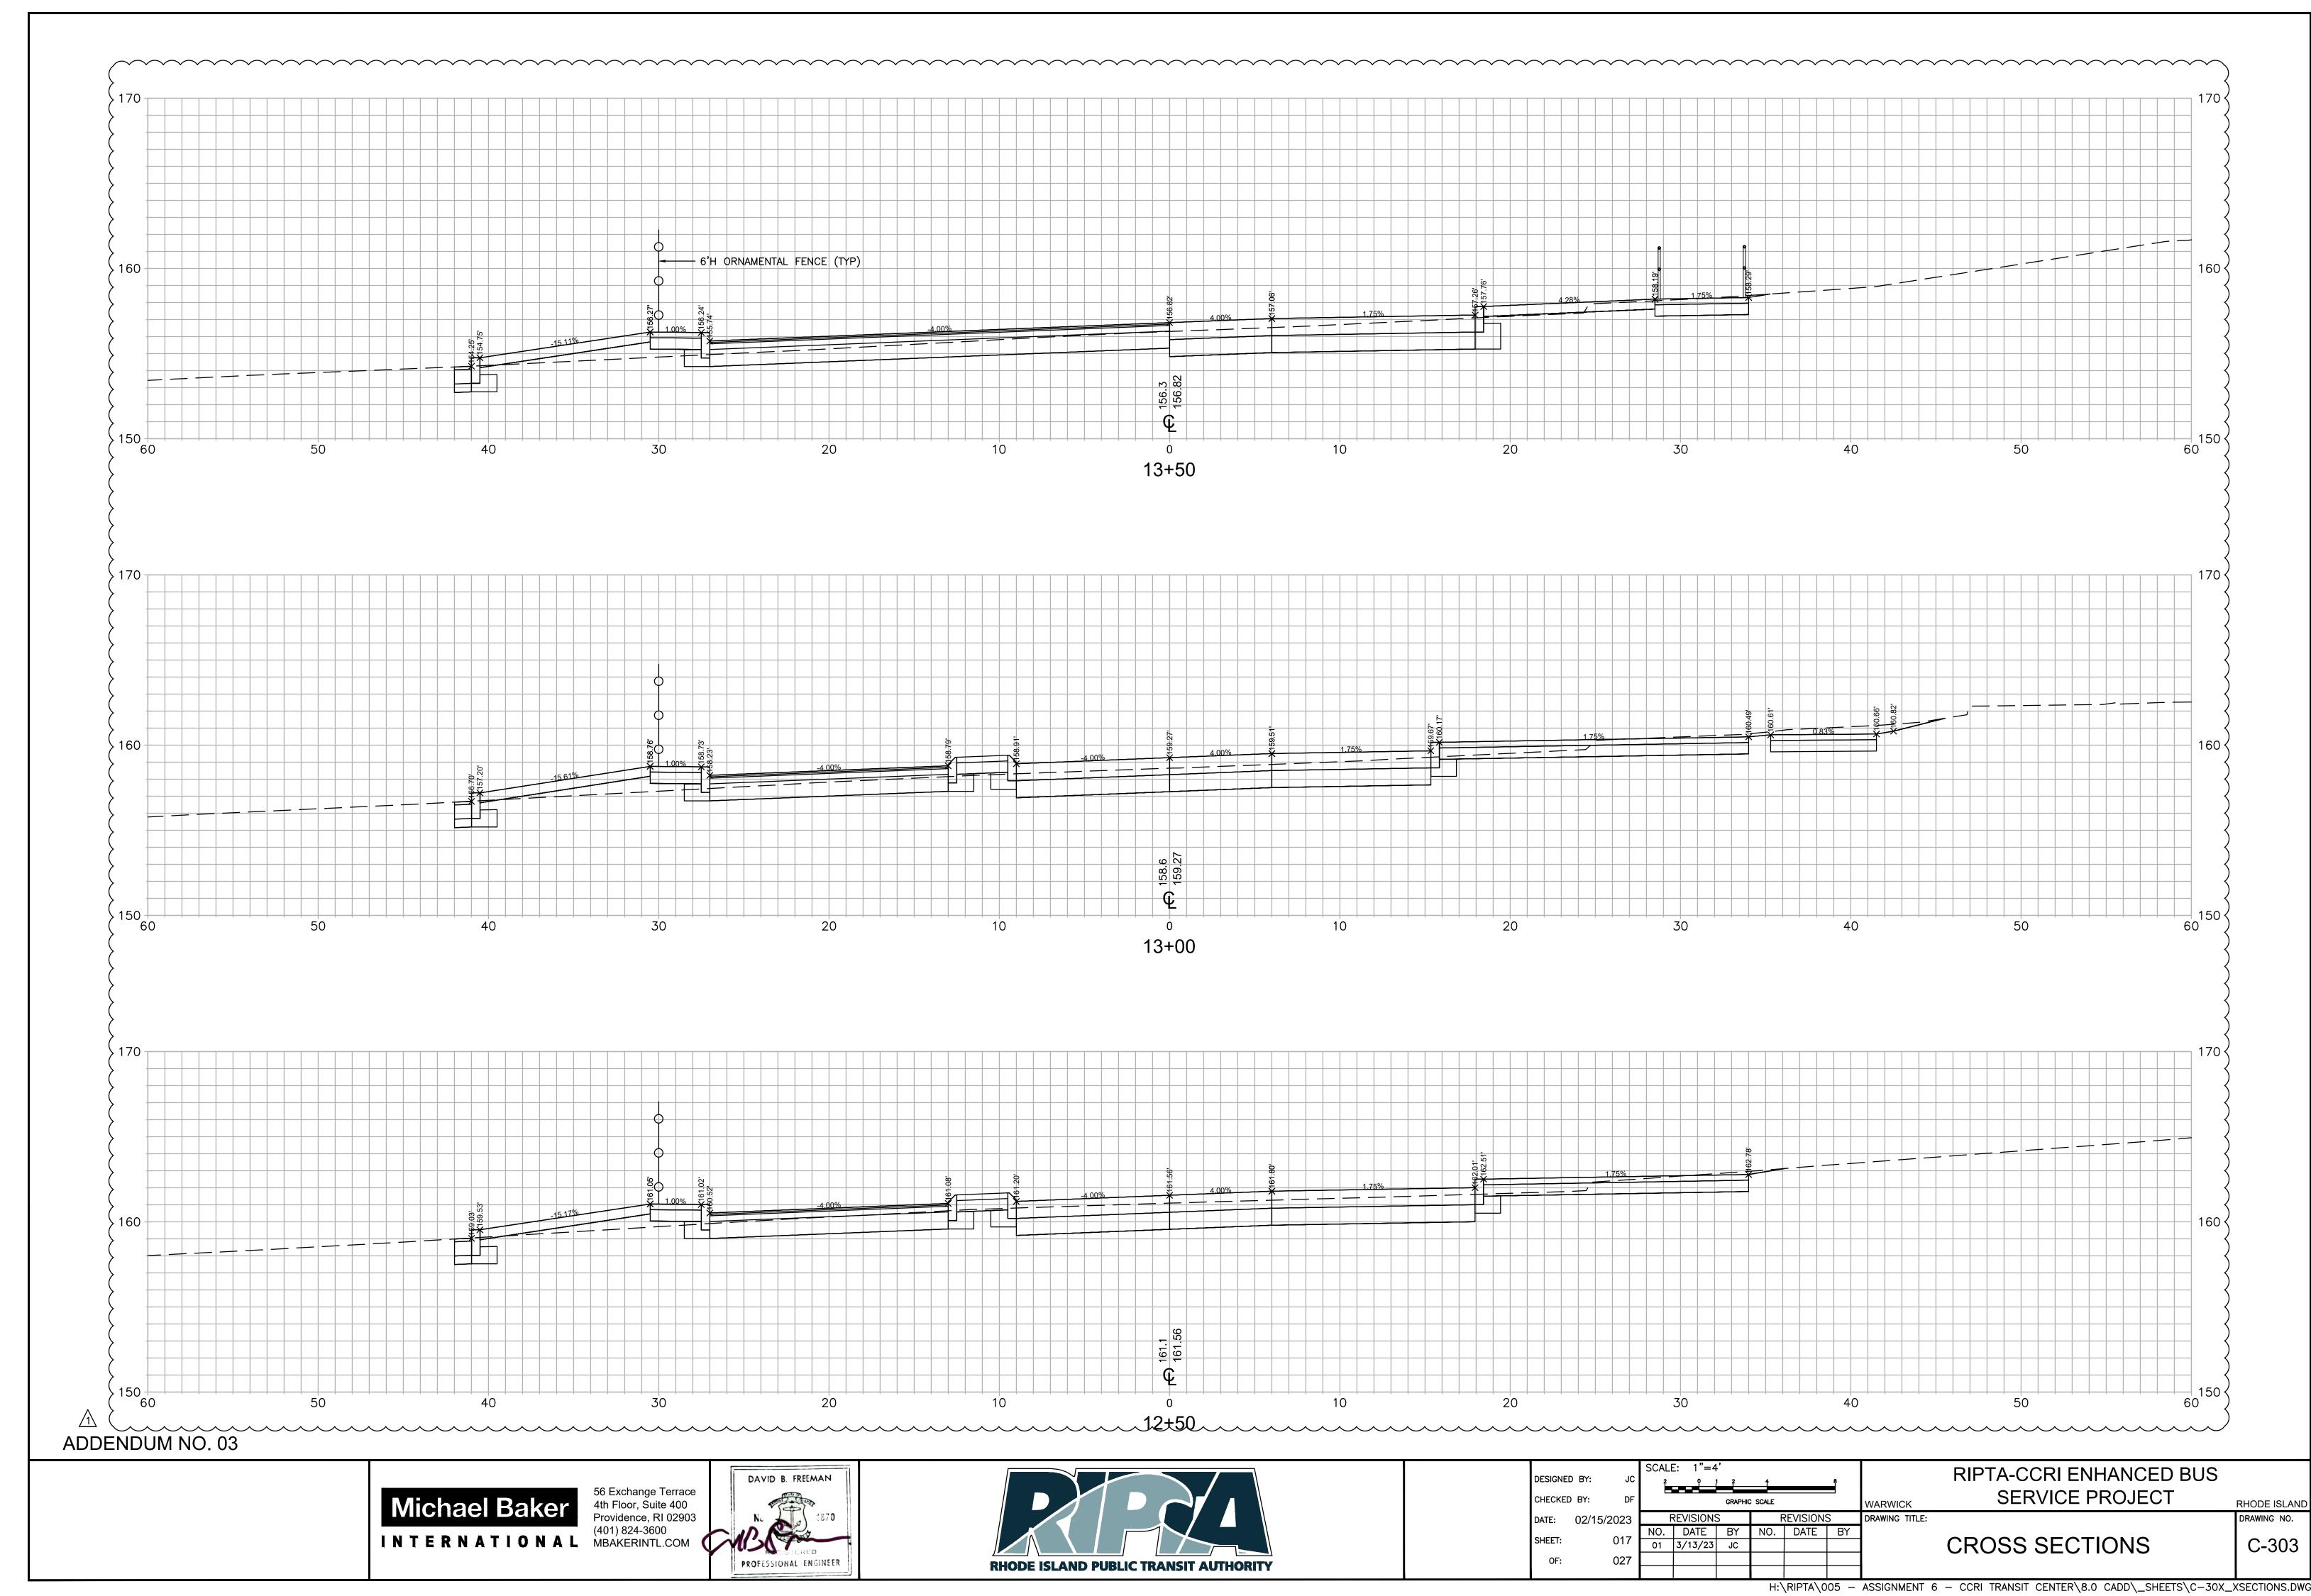








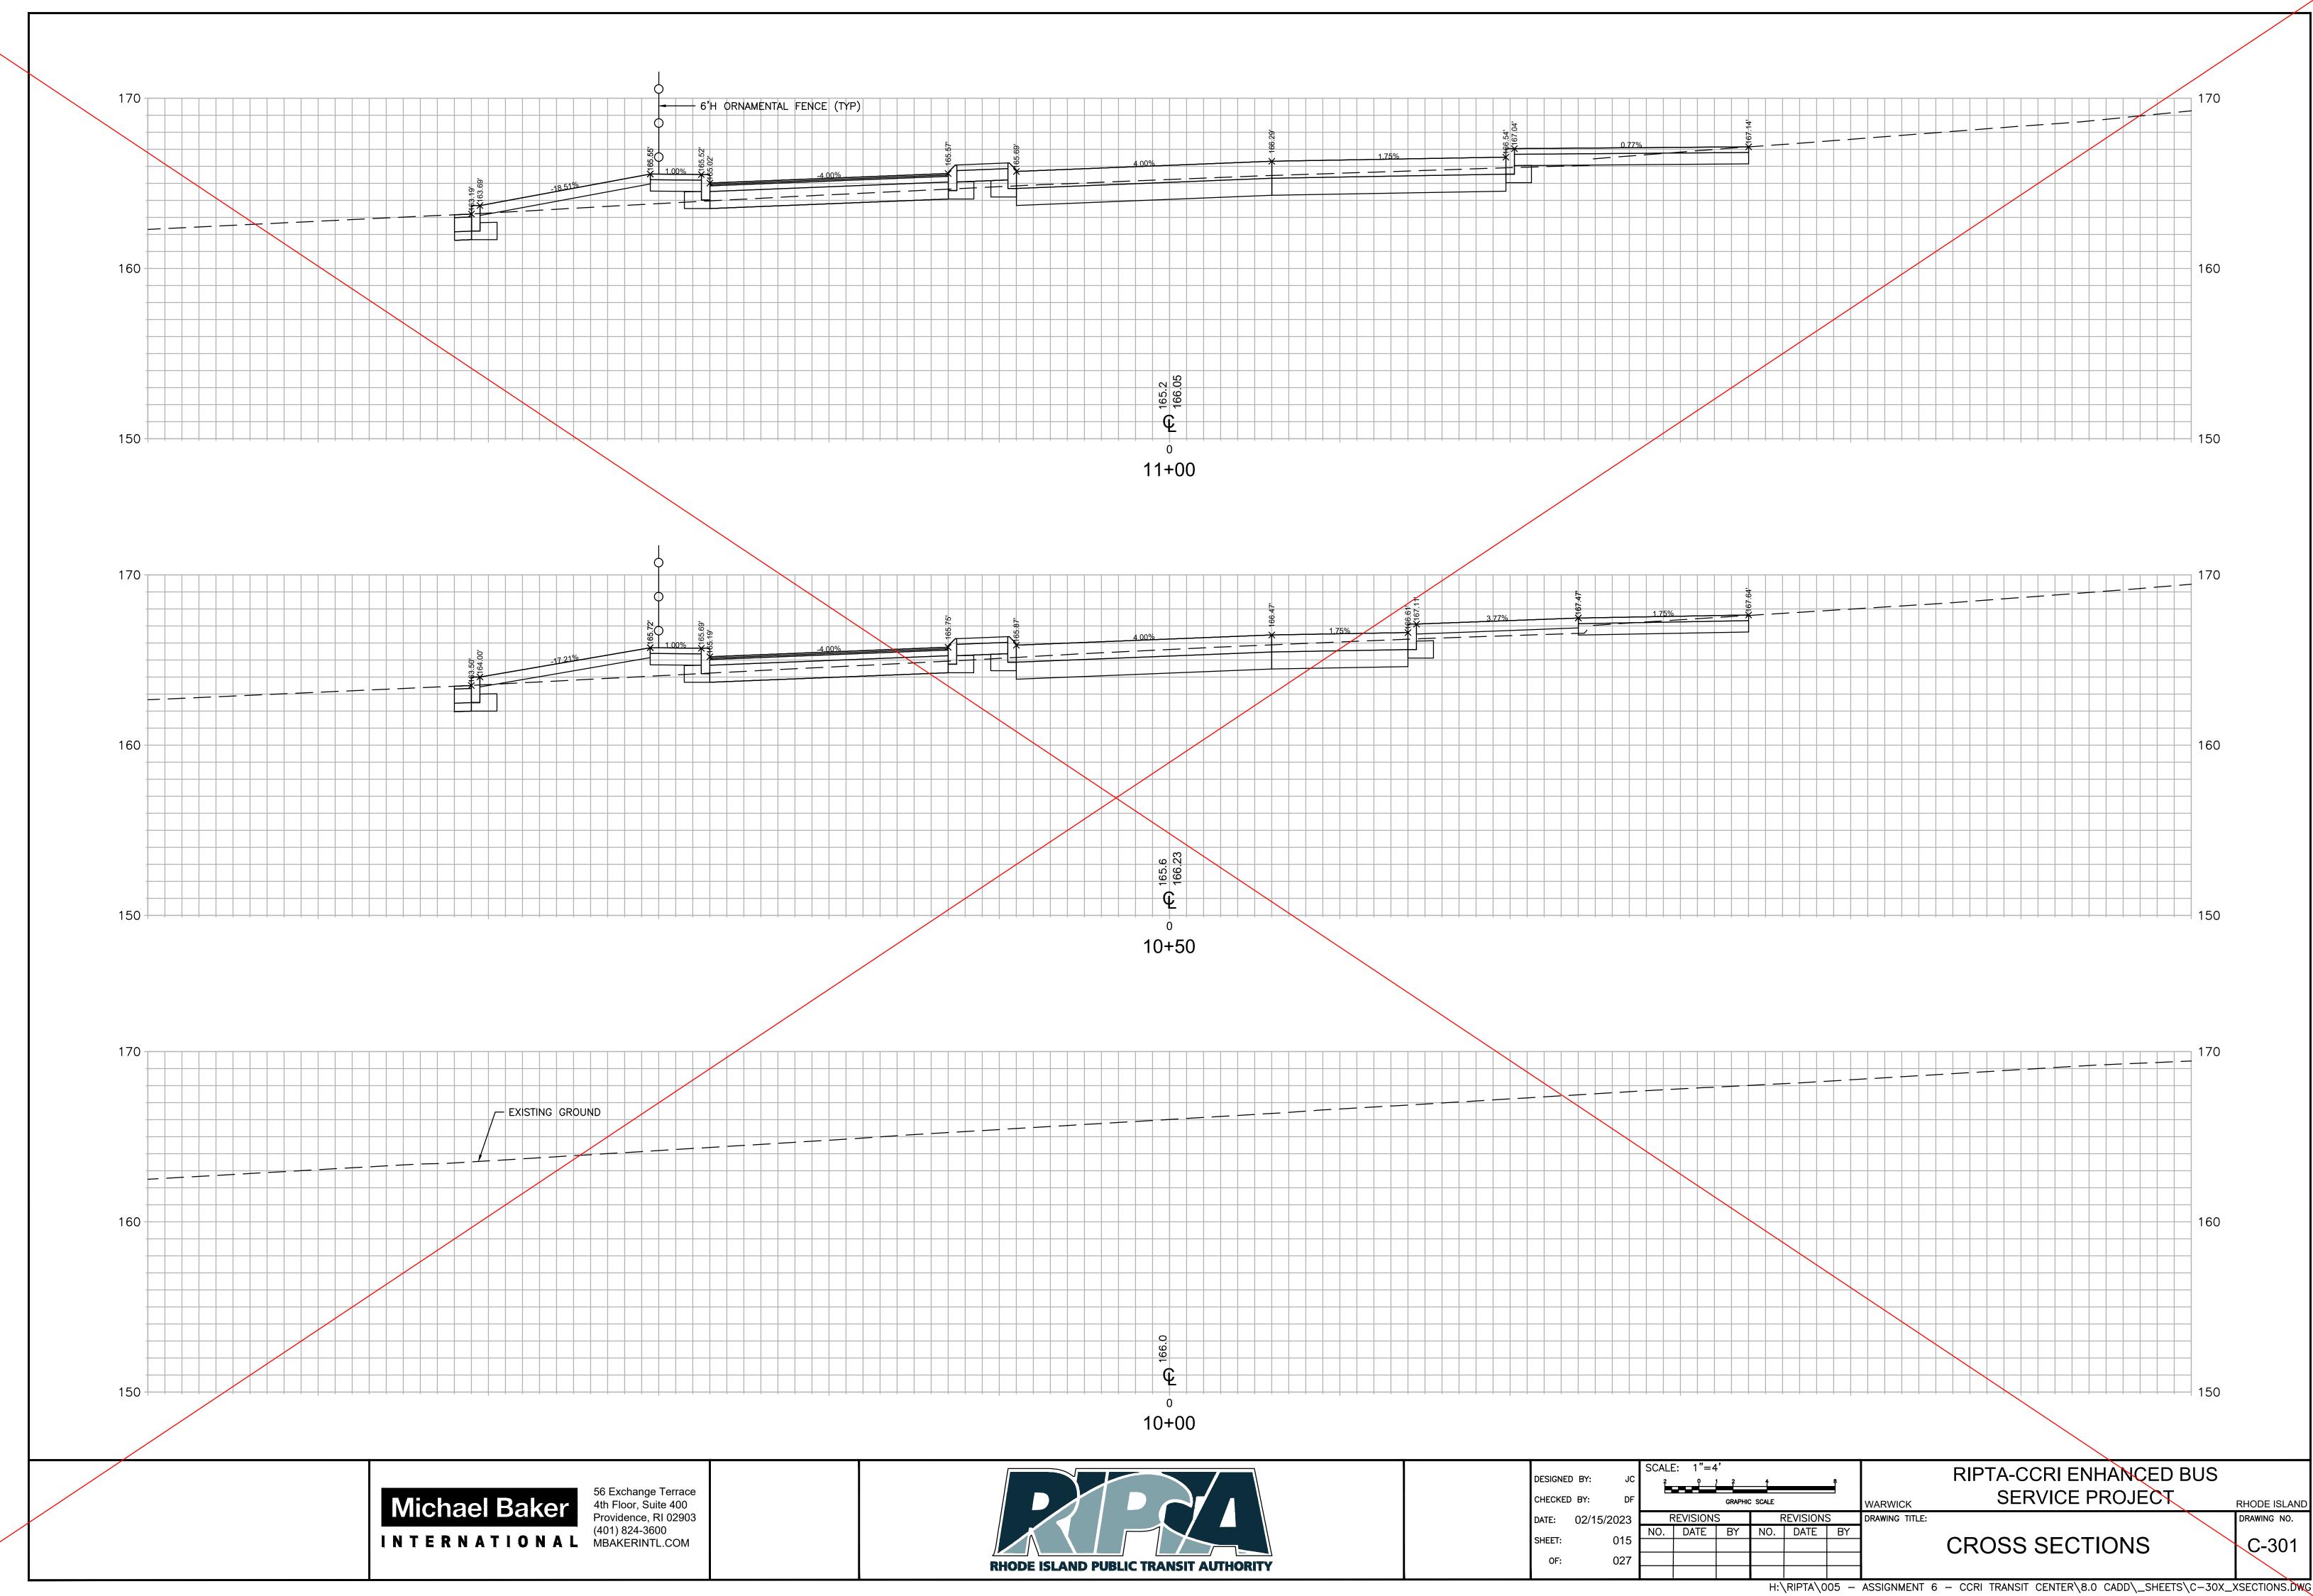


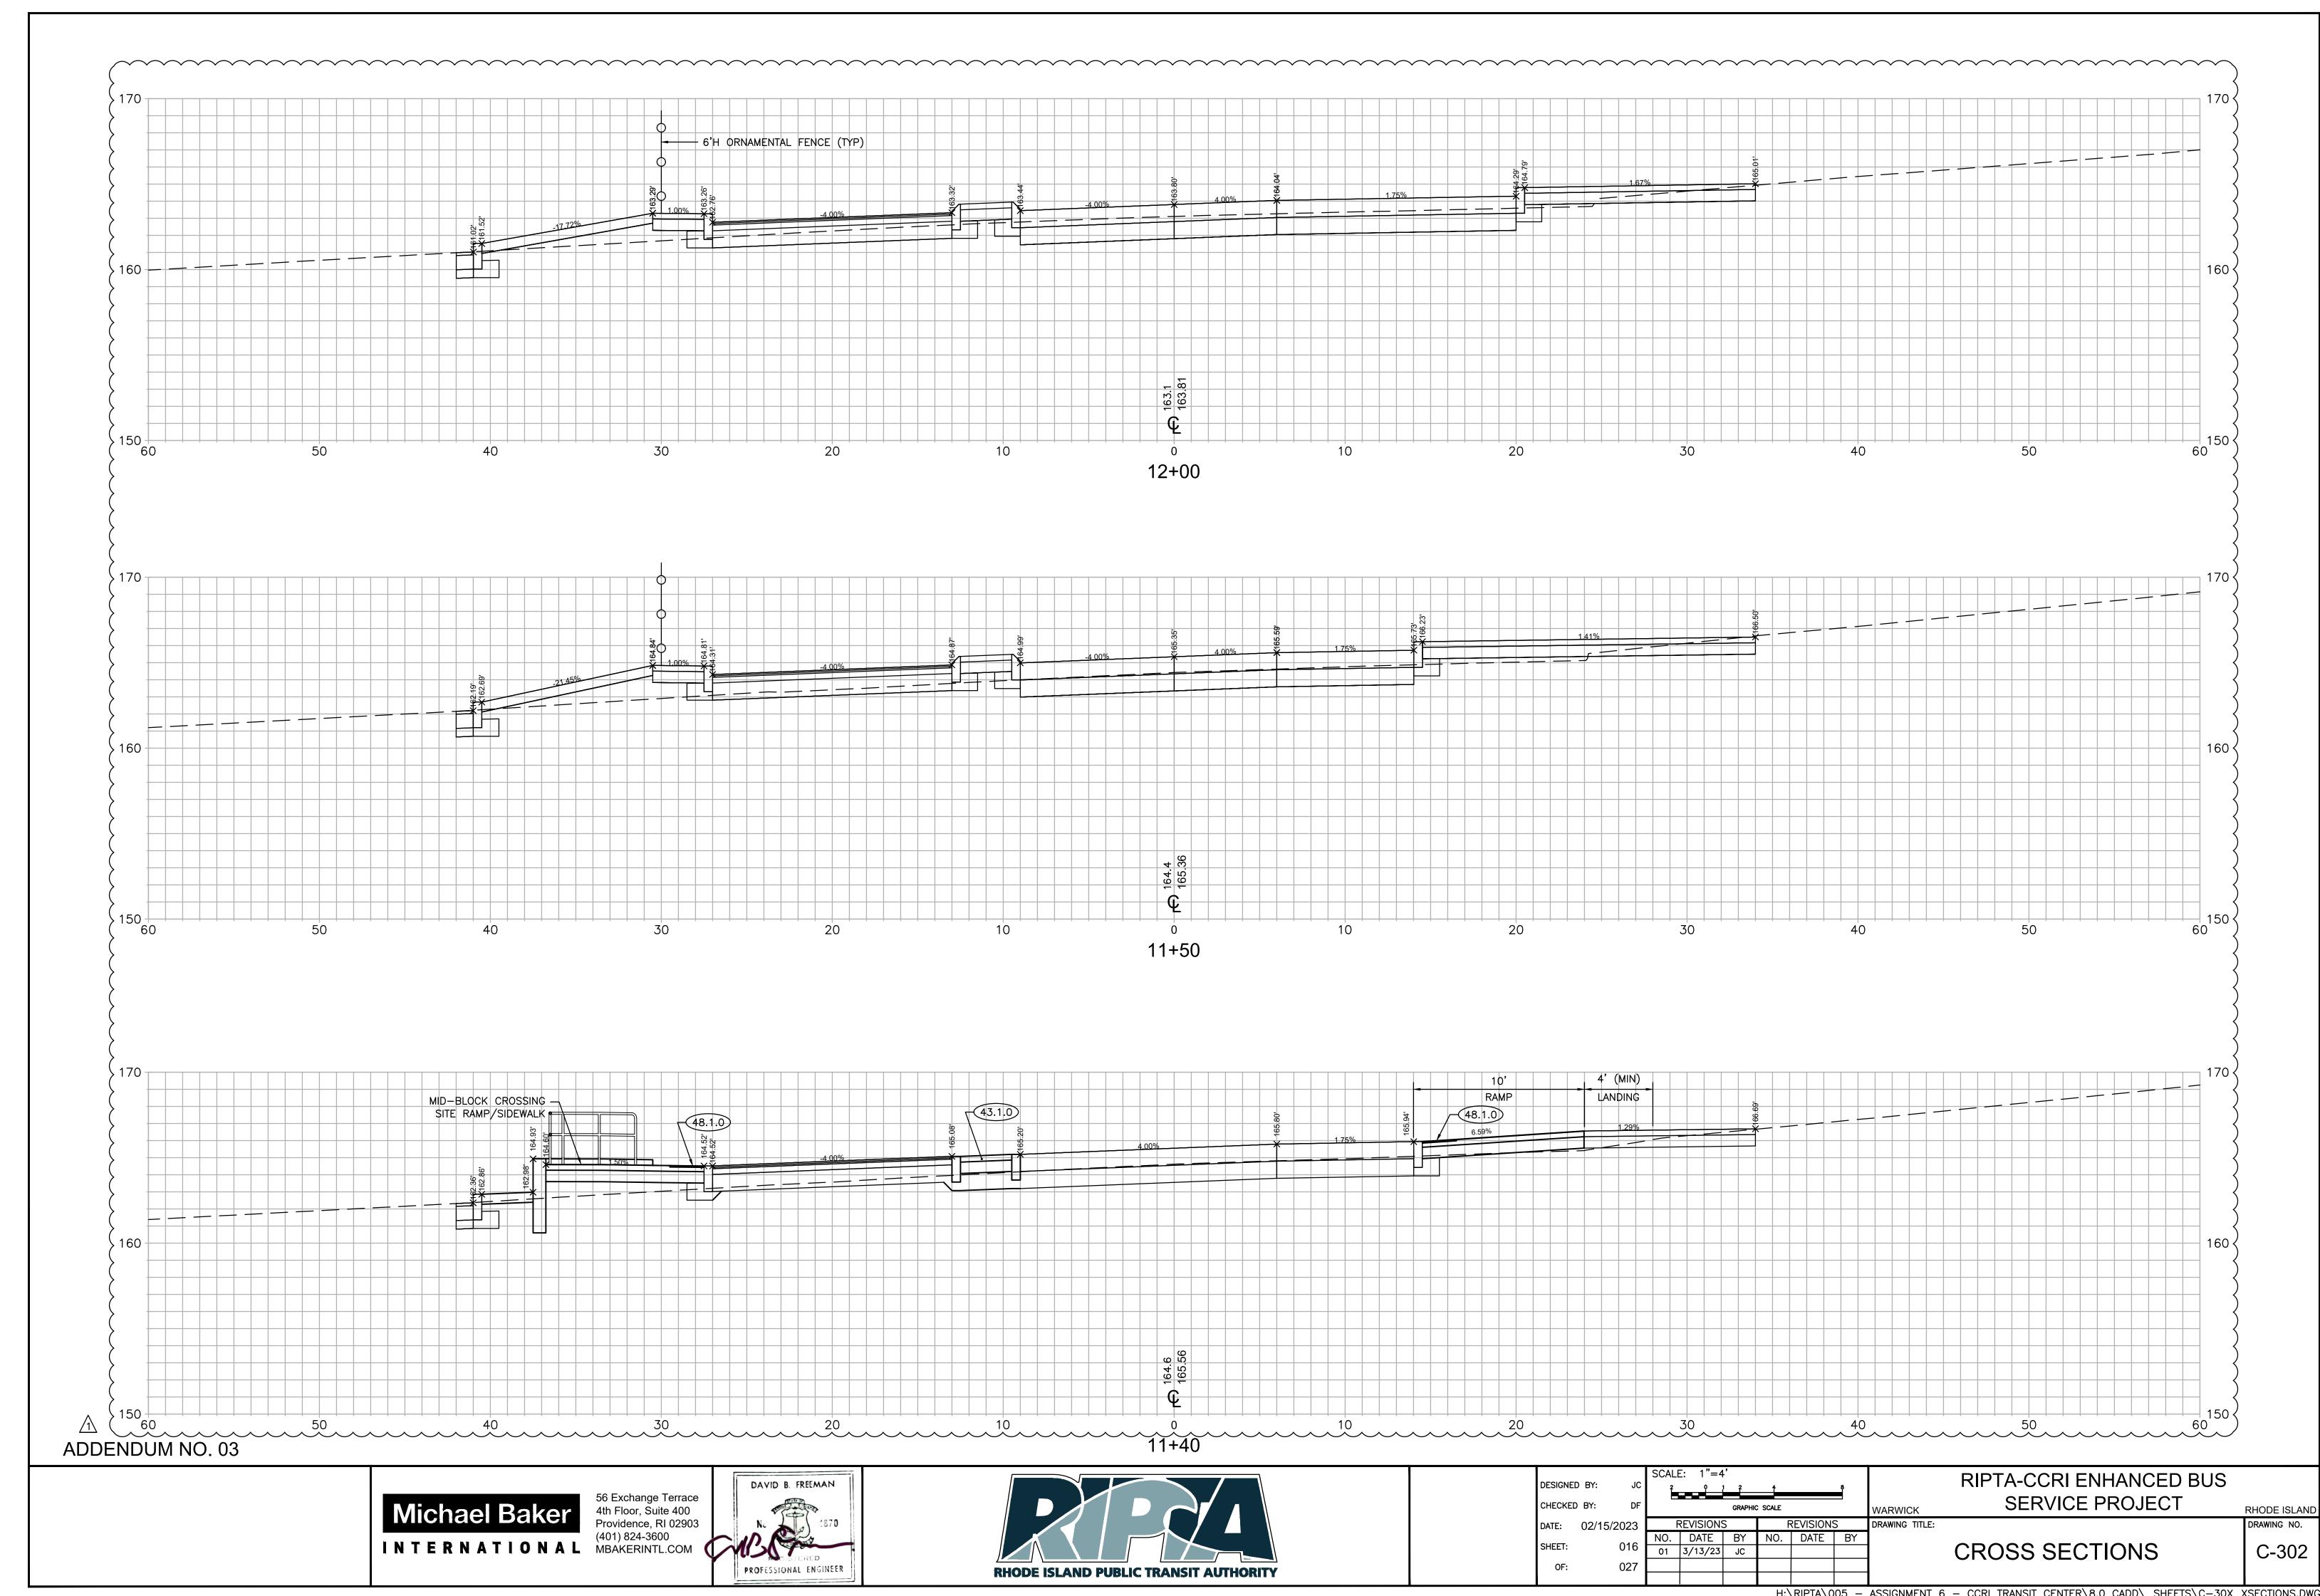


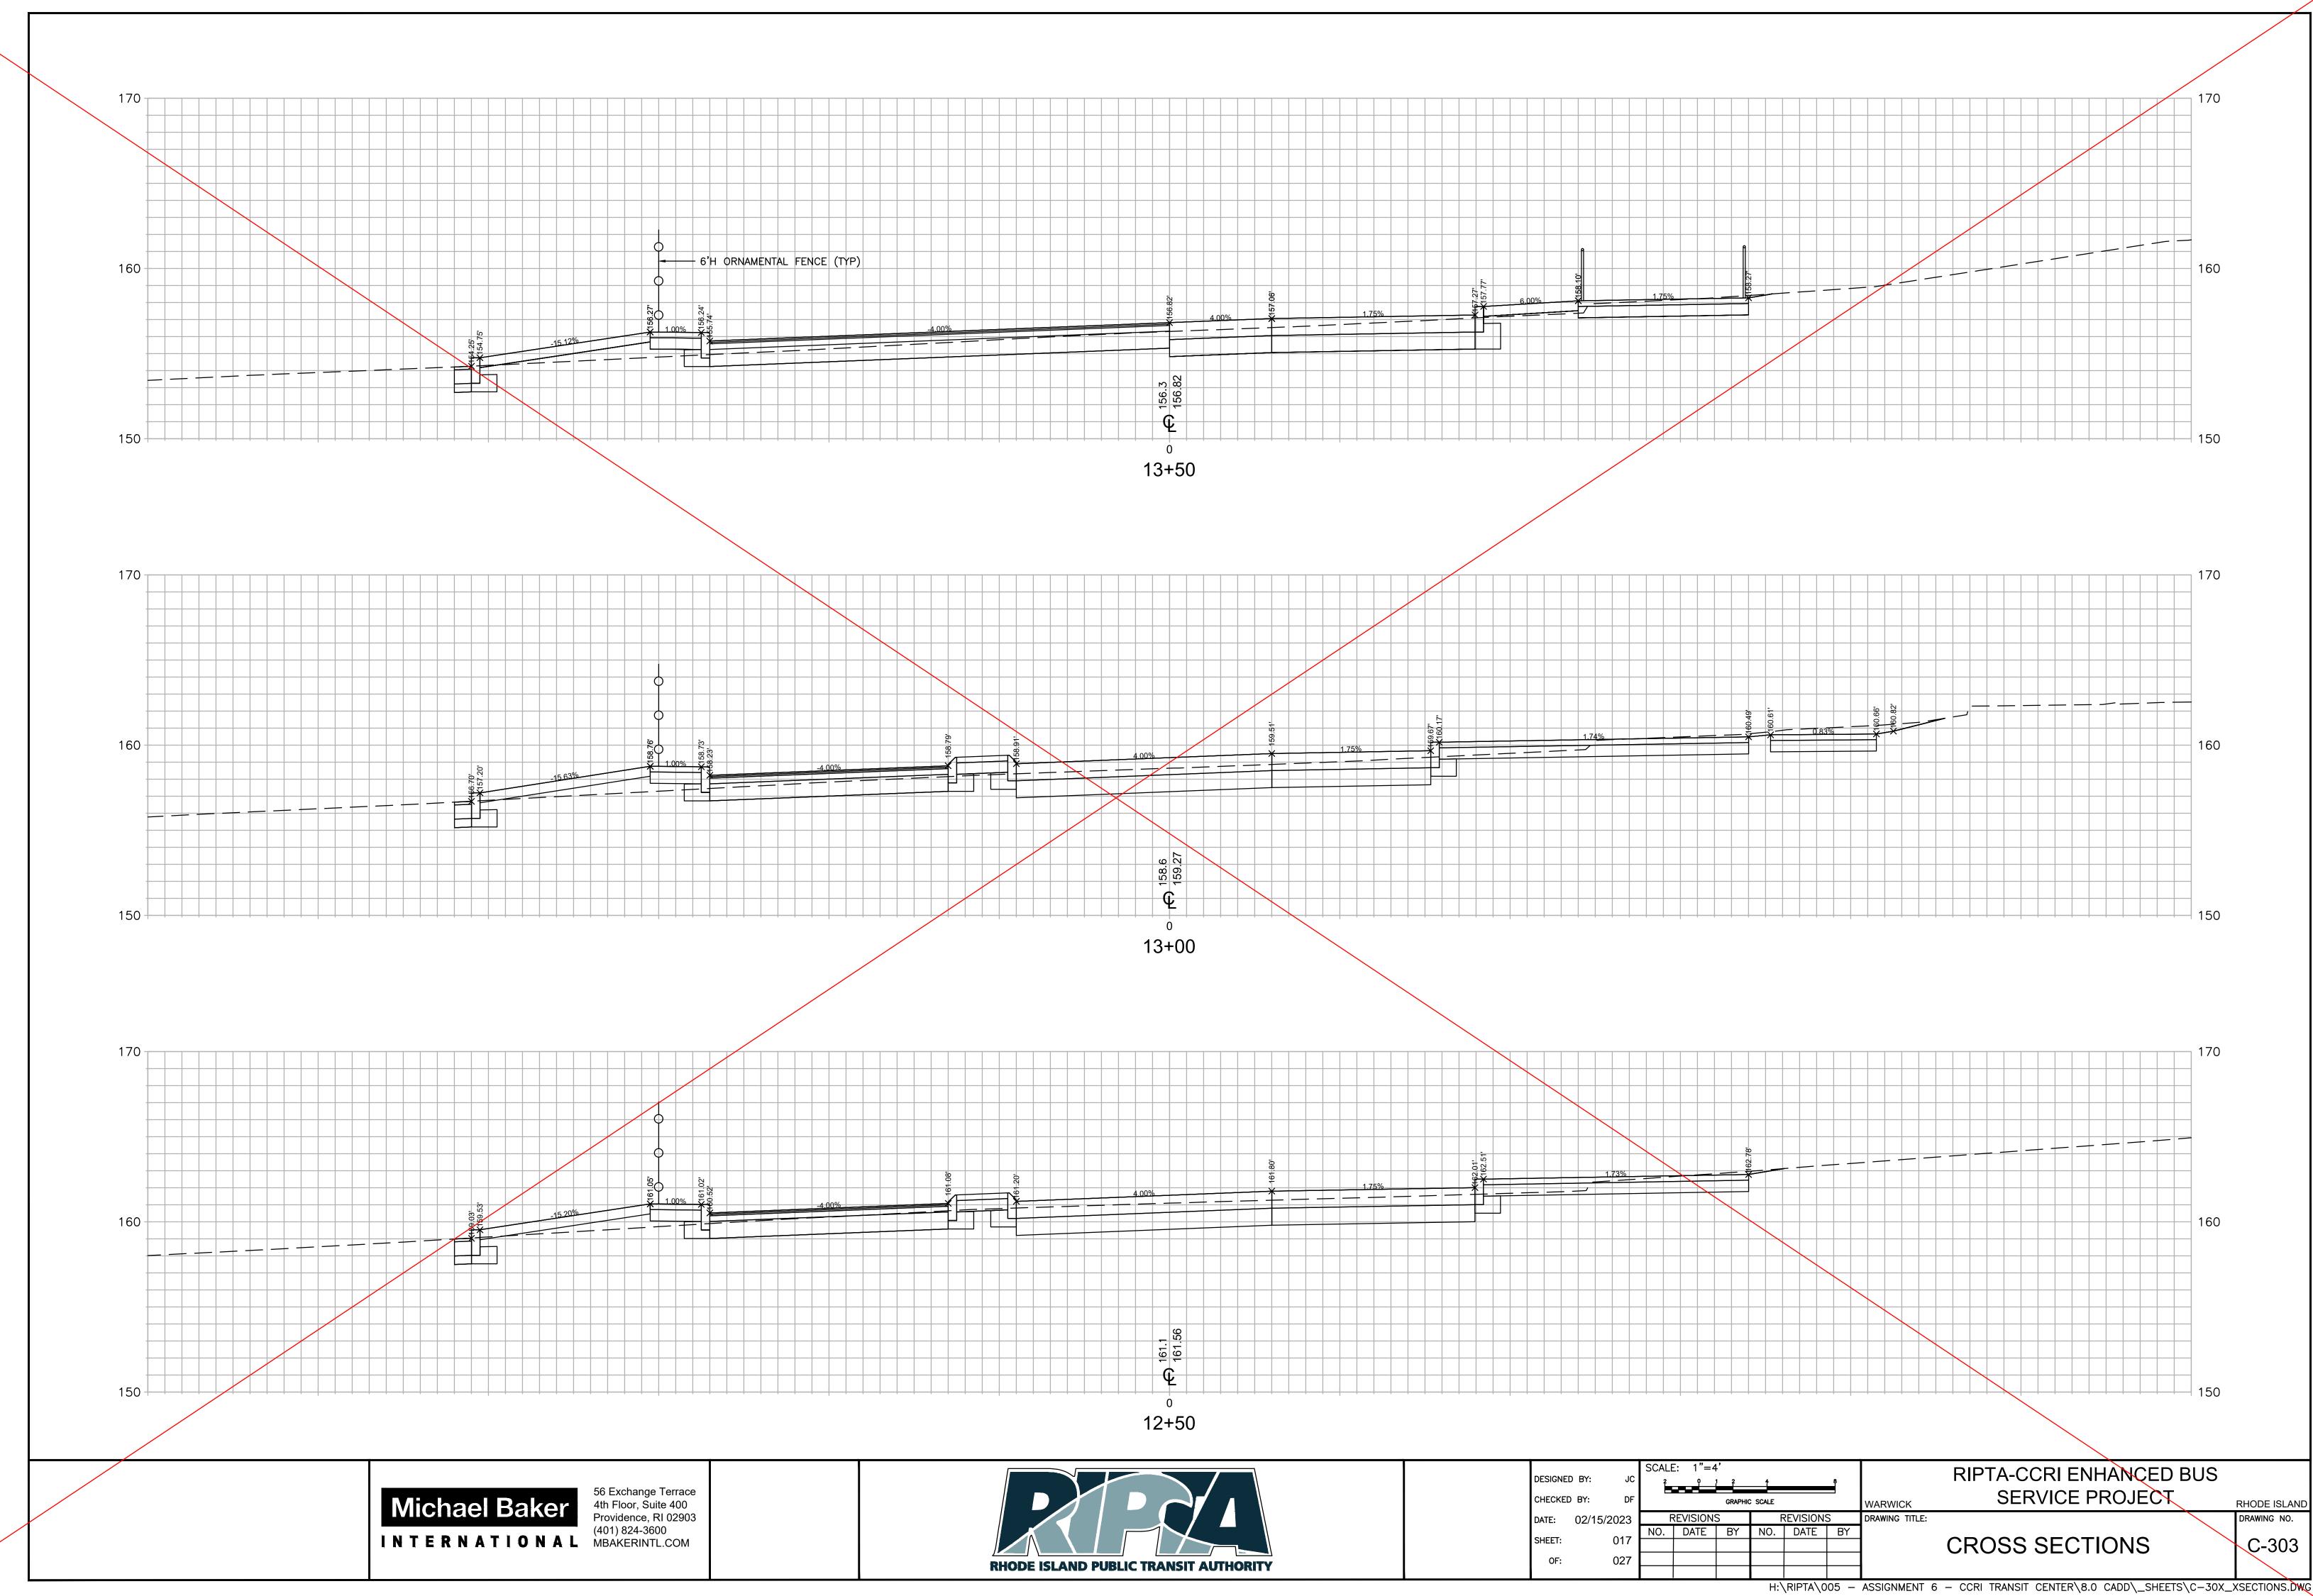

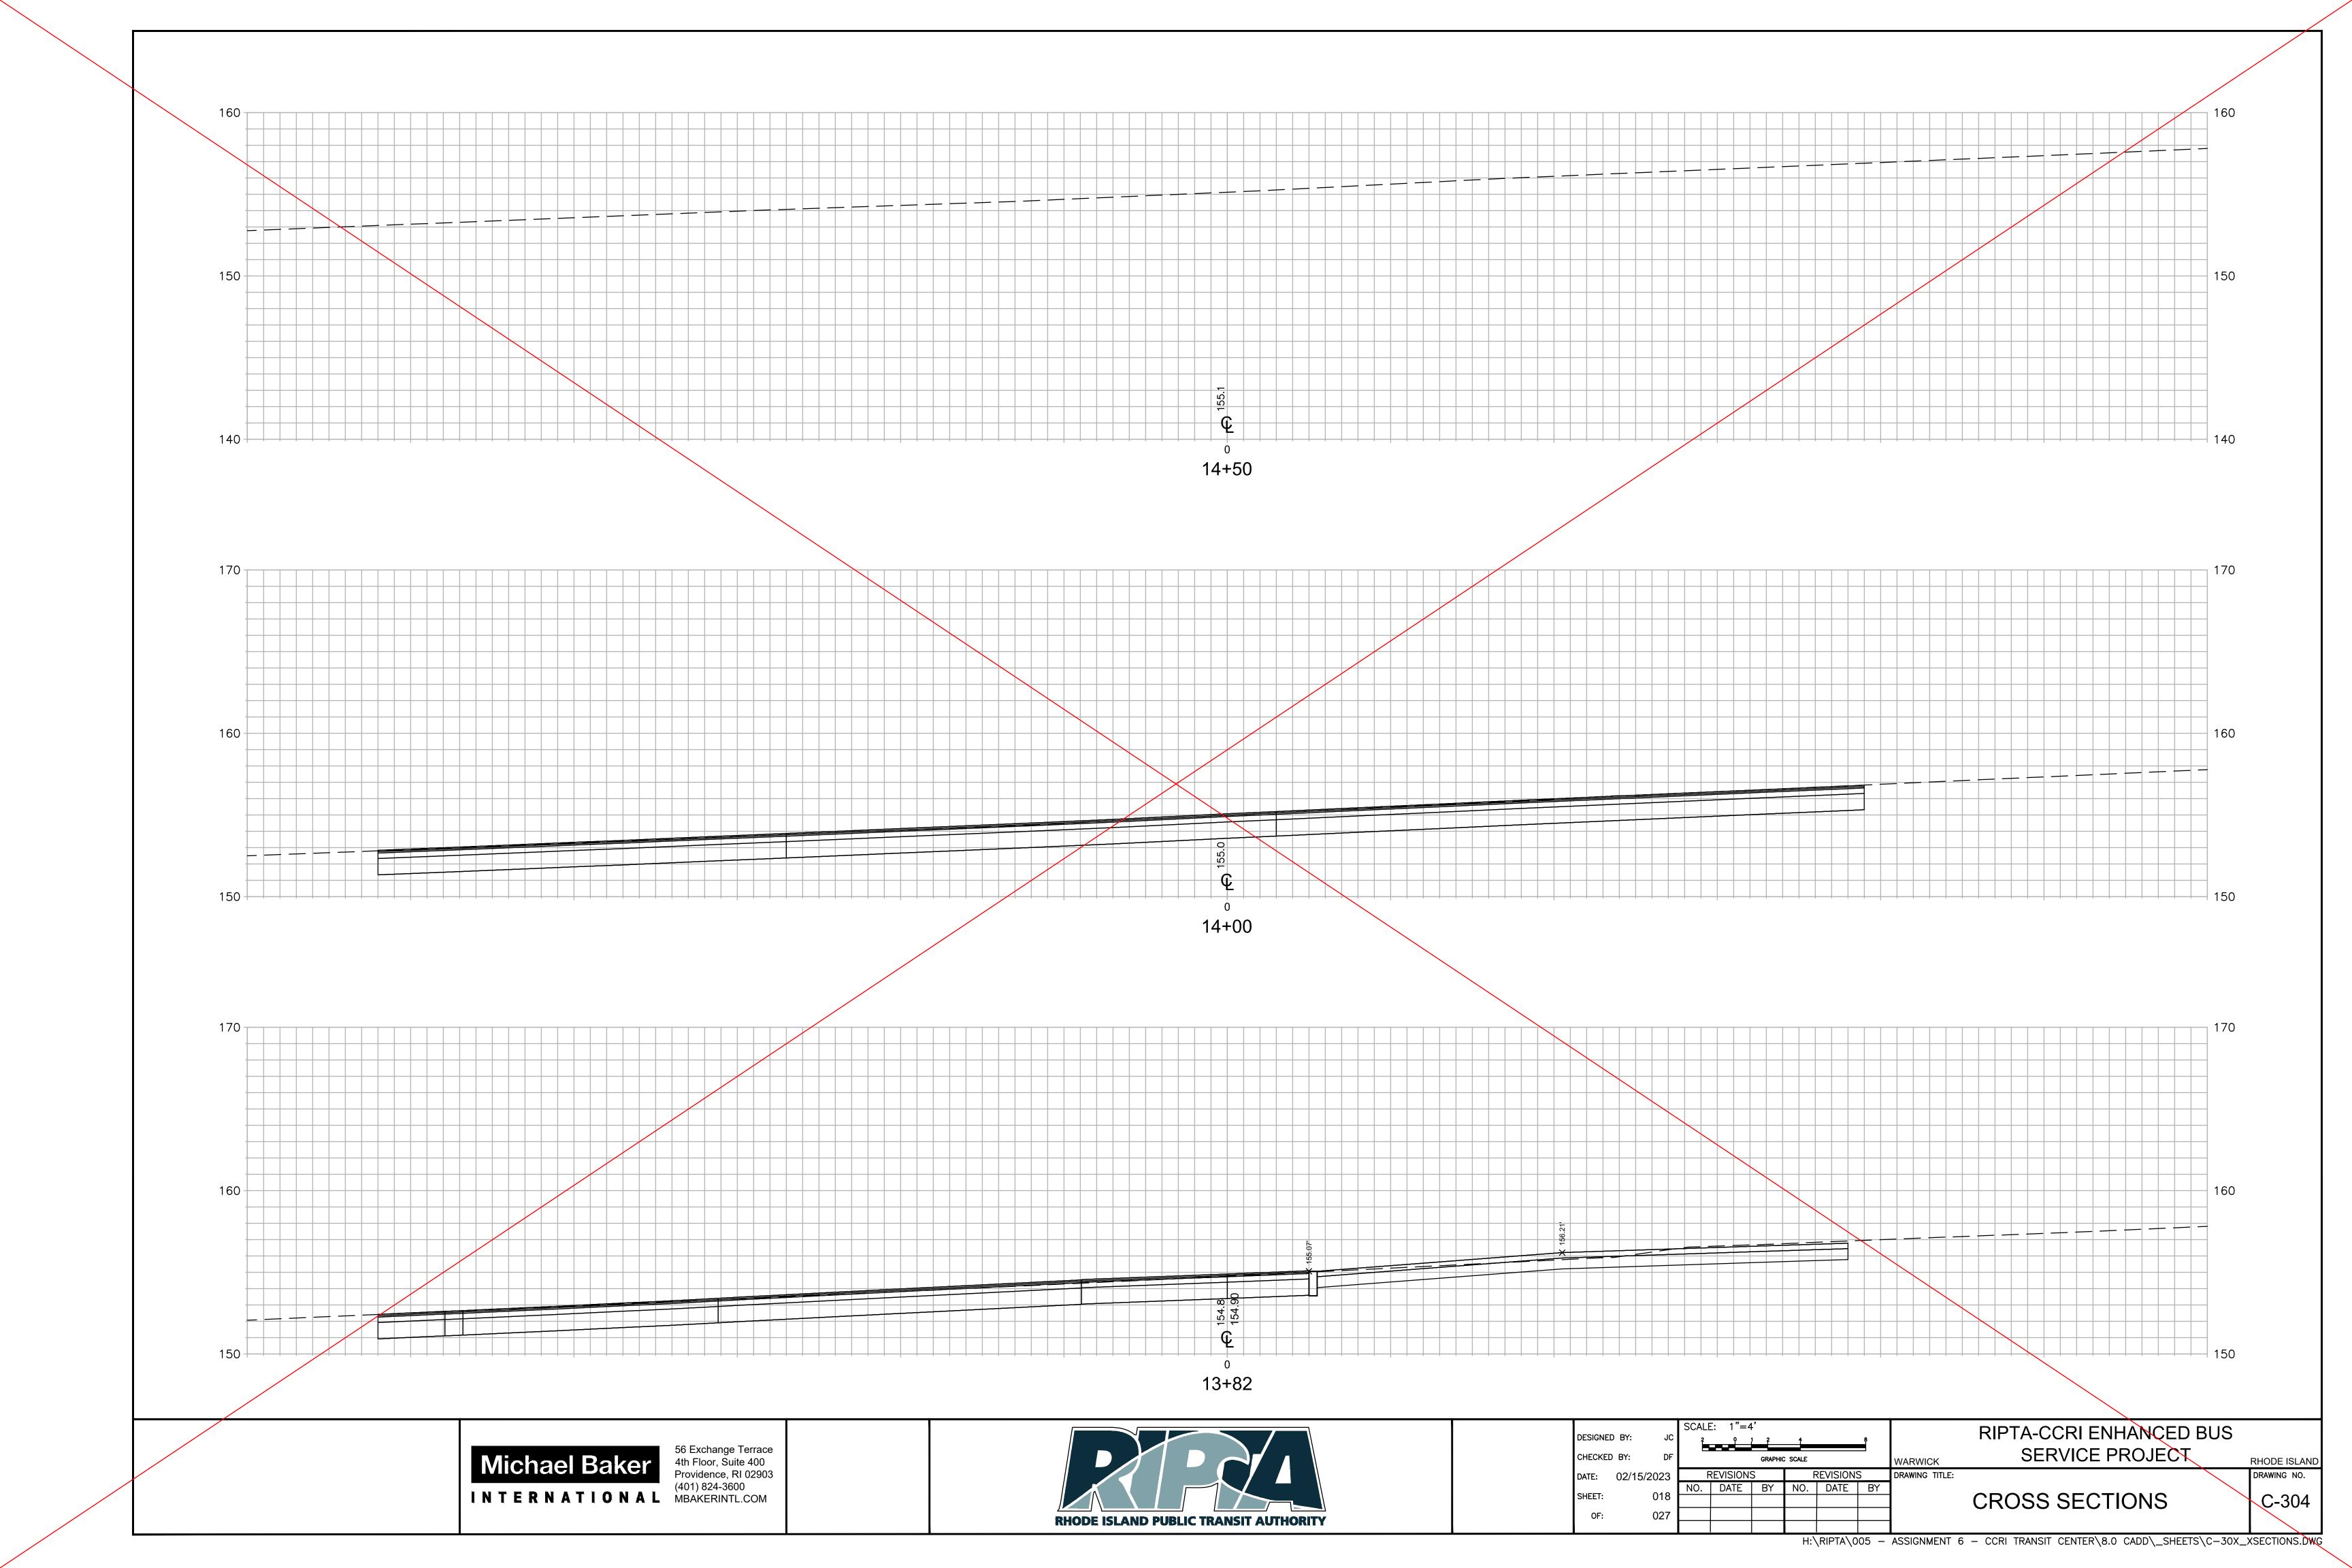


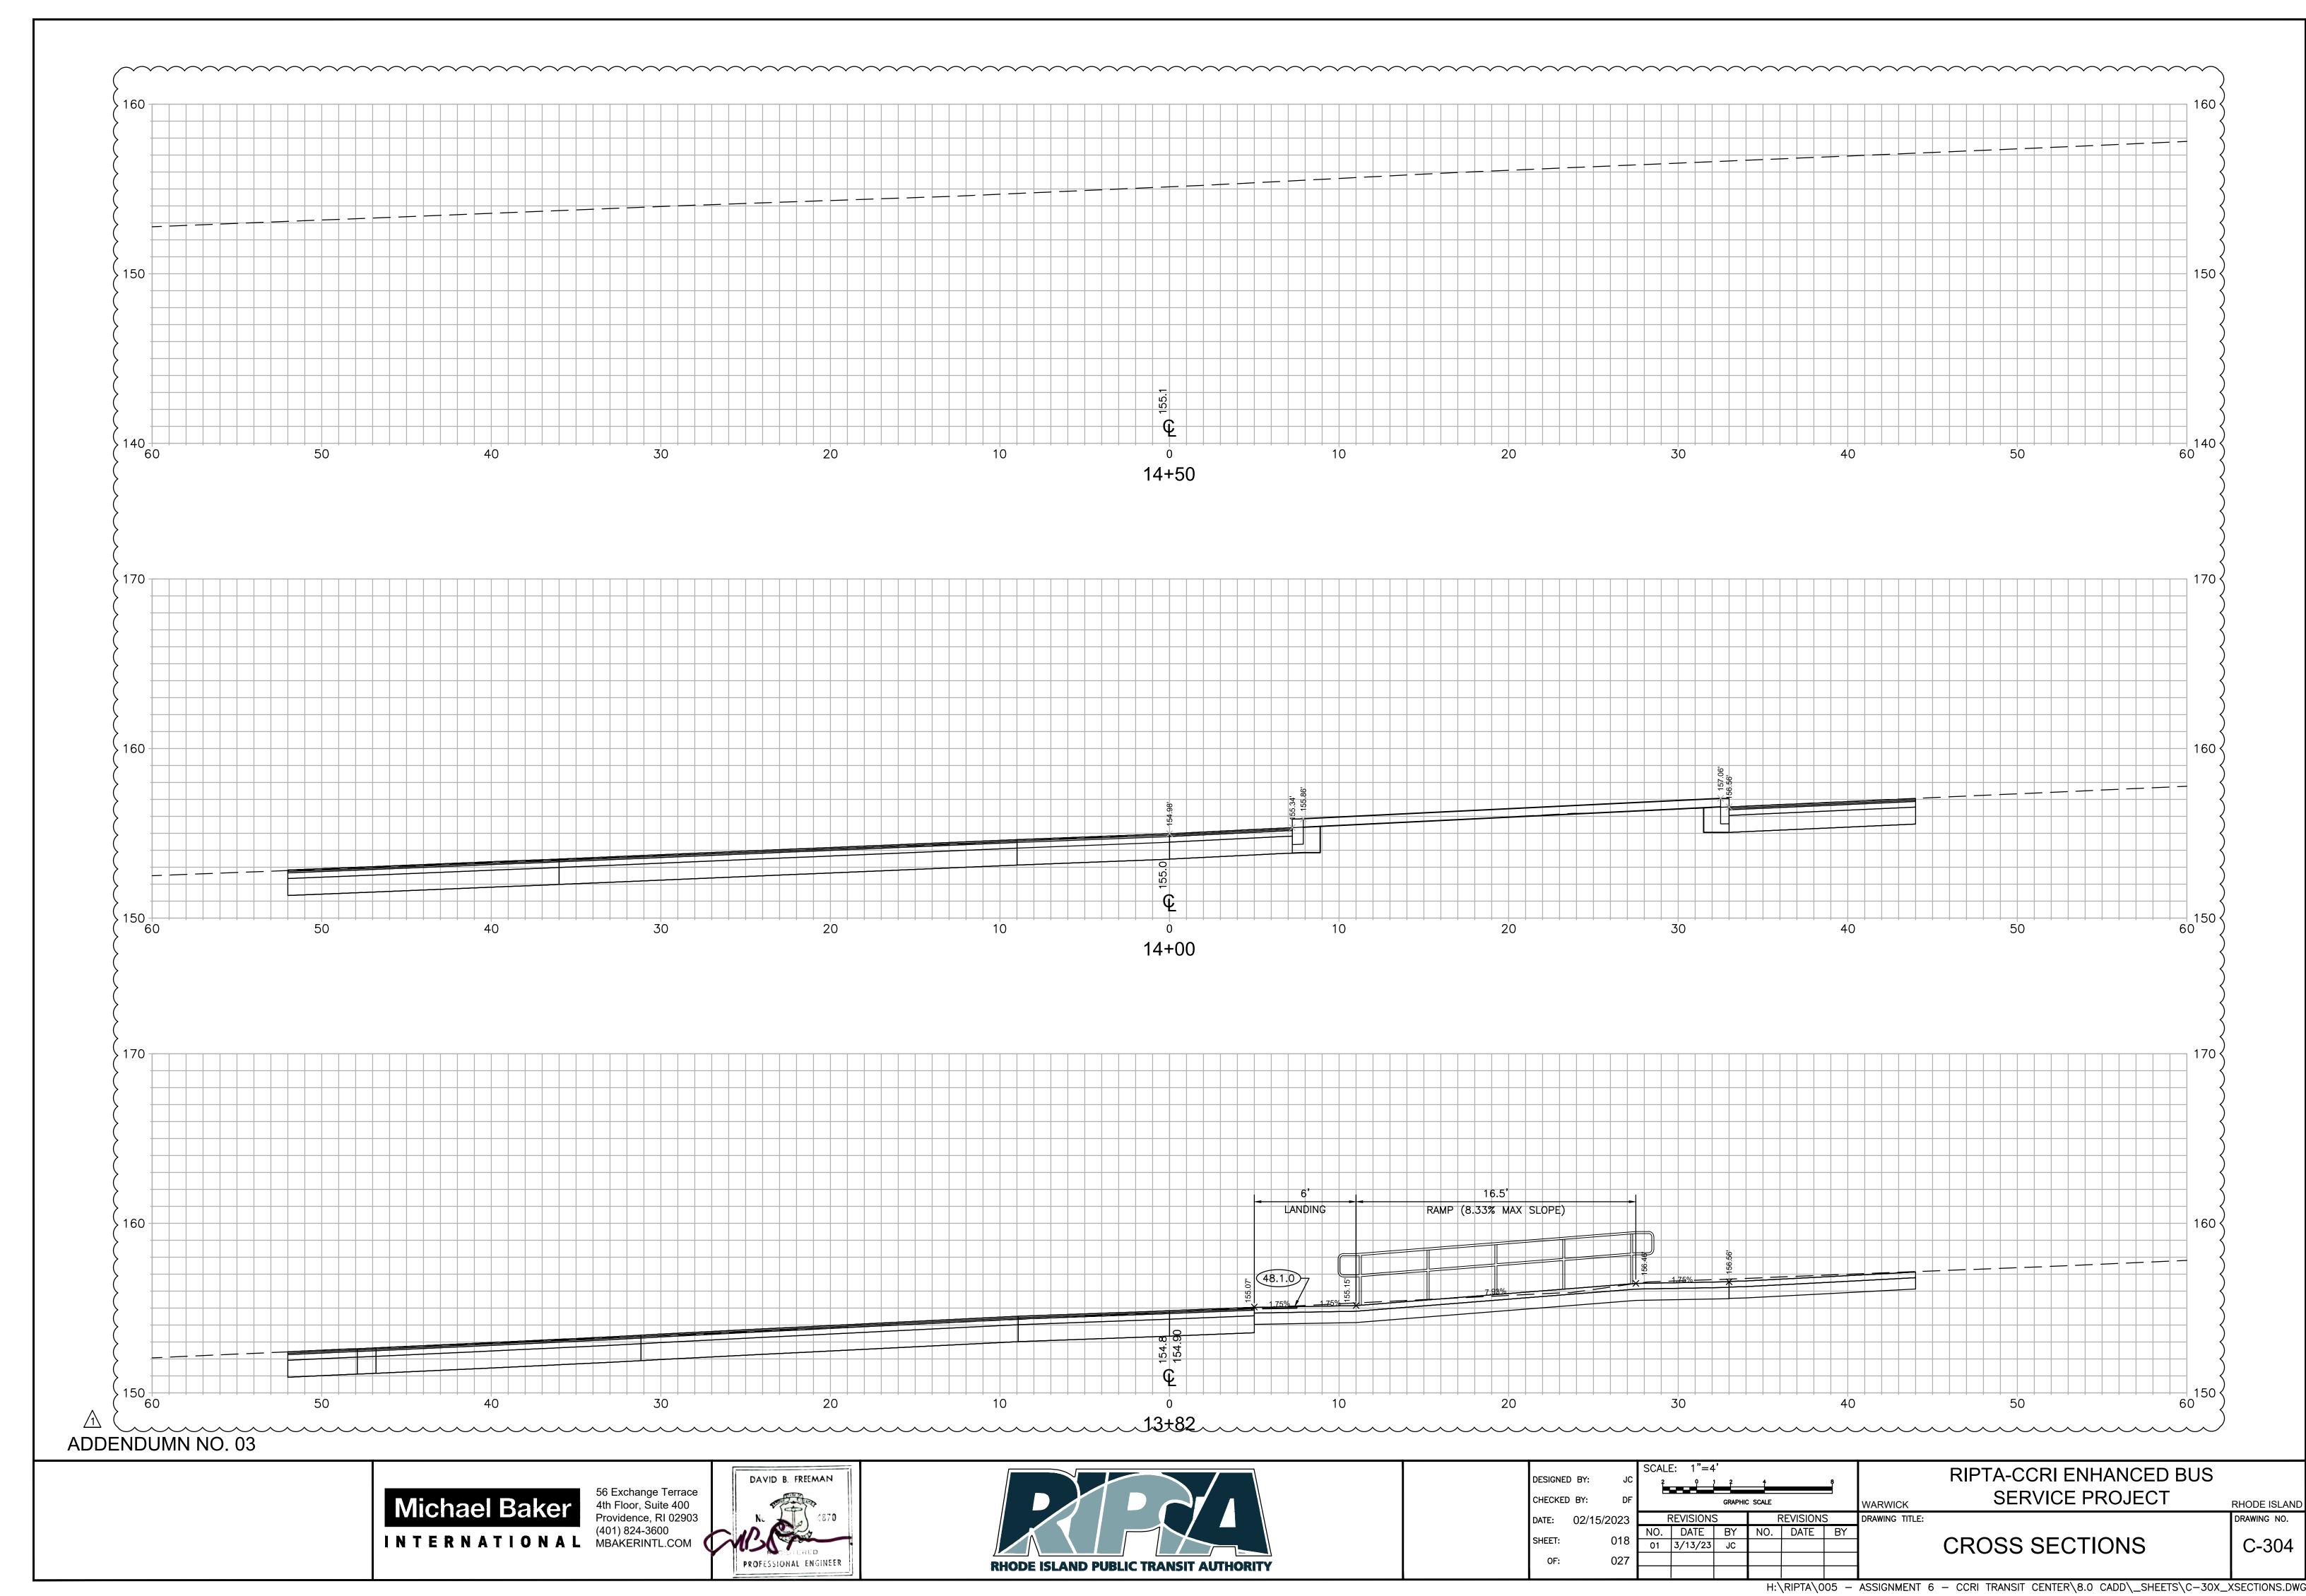

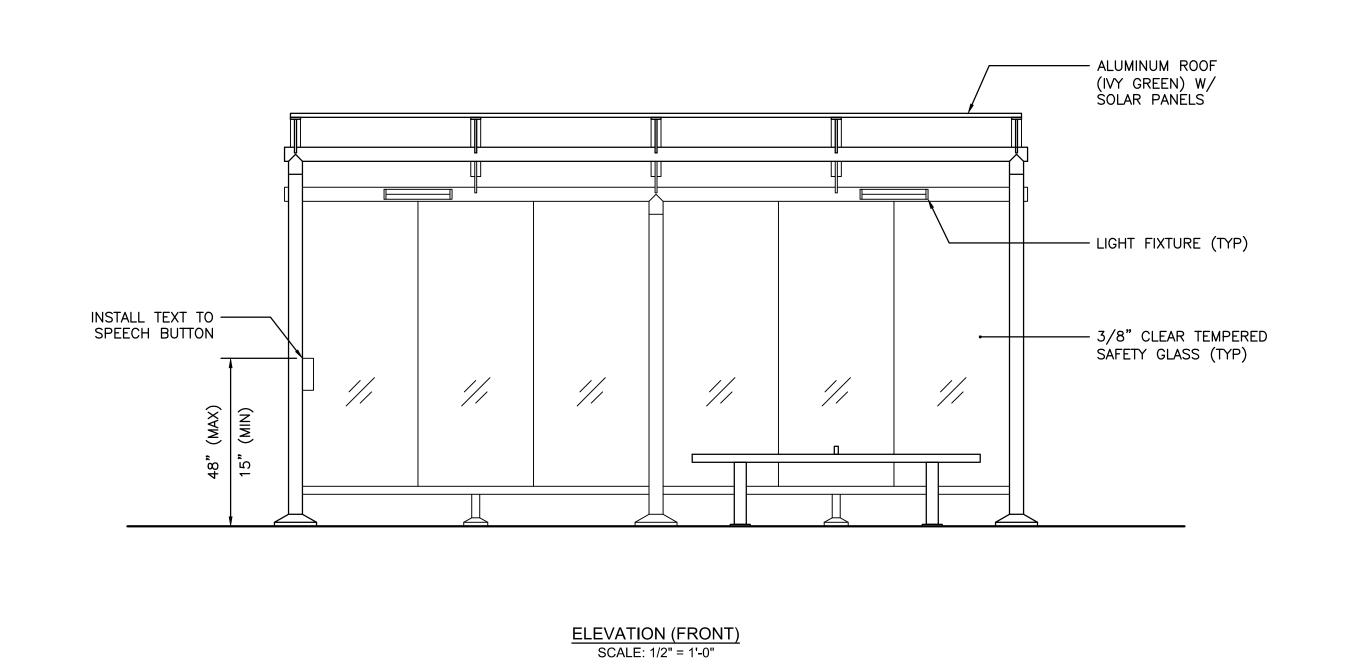


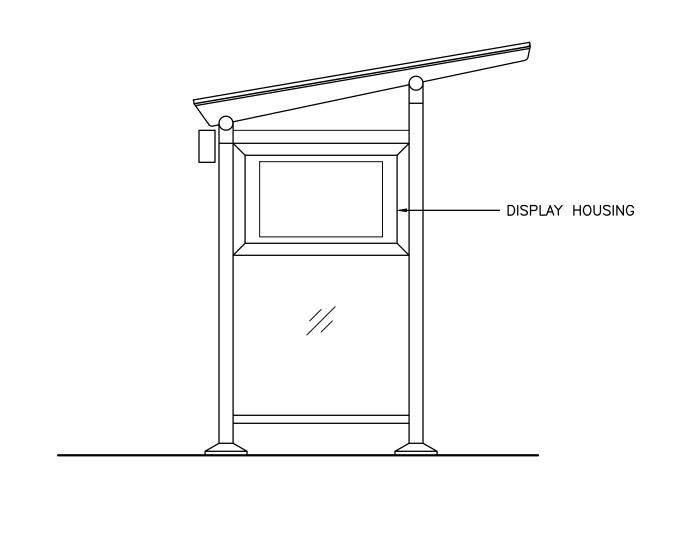


ELEVATION (LEFT SIDE)
SCALE: 1/2" = 1'-0"

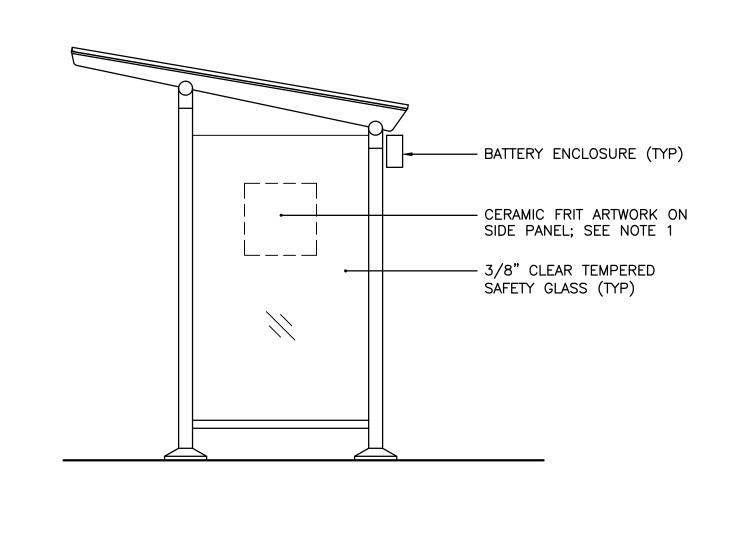

ELEVATION (RIGHT SIDE)
SCALE: 1/2" = 1'-0"

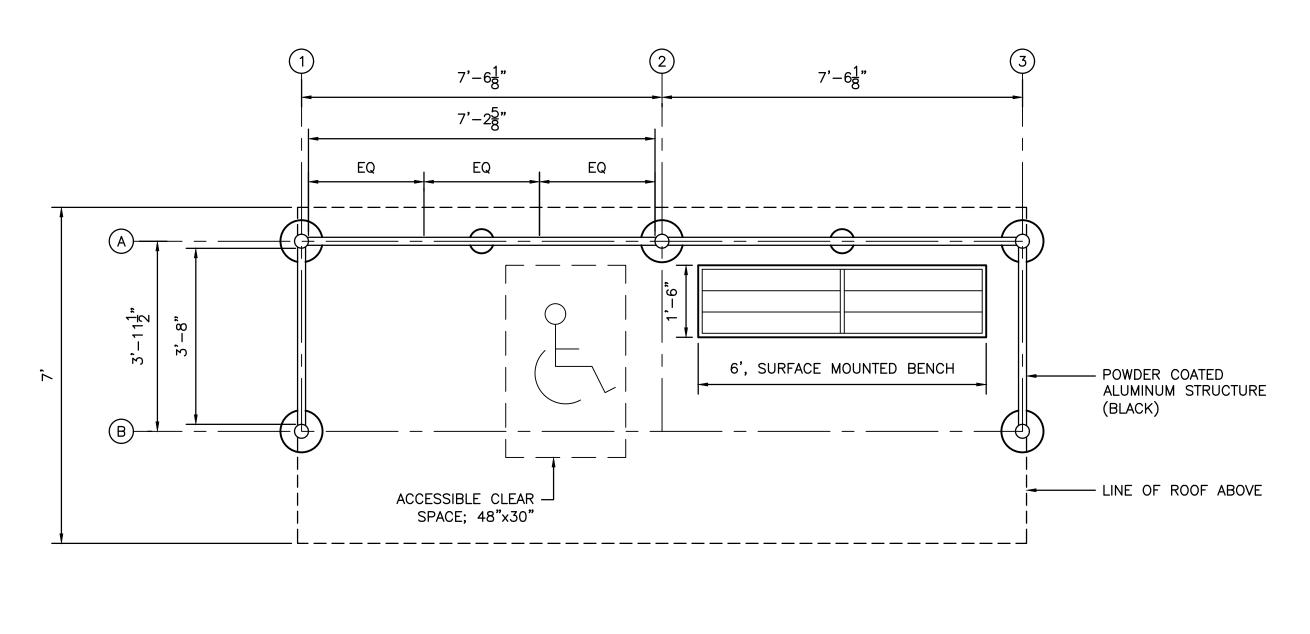

BUS SHELTER - PLAN SCALE: 1/2" = 1'-0"

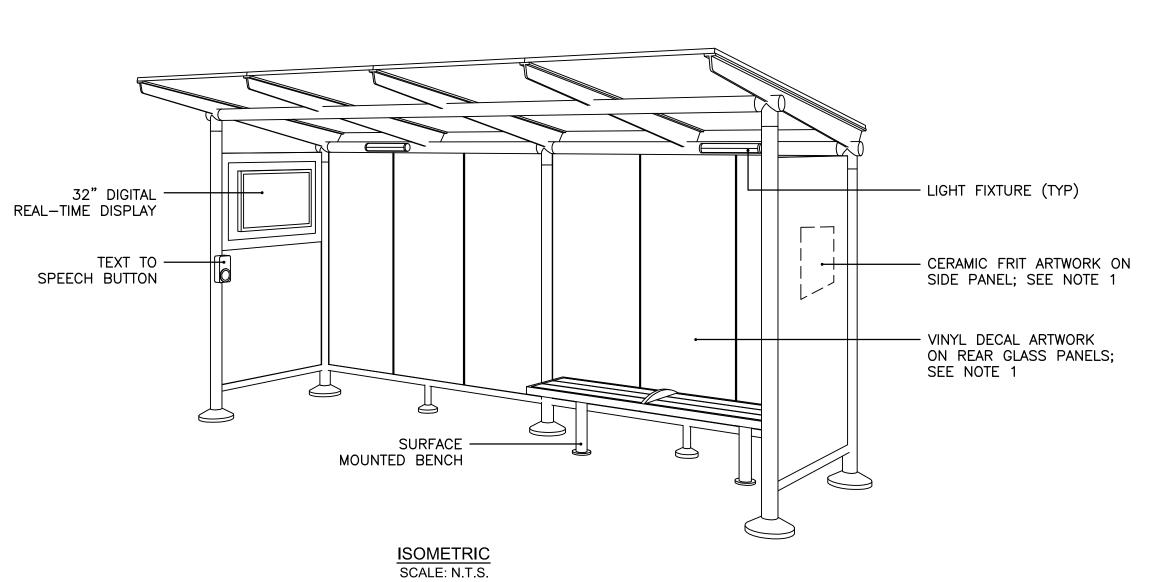

NOTES:

1. ARTWORK DESIGN AND VECTOR FILE(S) TO BE SUPPLIED BY OWNER.

2. BUS SHELTERS SHALL PROVIDE A MINIMUM CLEAR FLOOR OR GROUND SPACE COMPLYING WITH ADA 2010 SECTION 305.


Michael Baker


Michael Baker


S6 Exchange Terrace
4th Floor, Suite 400
Providence, RI 02903
(401) 824-3600
MBAKERINTL.COM



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DESIGNED) BY: JC	SCALE	E: AS I	NOTED					RIPTA-CCRI ENHANCED BUS	
CHECKED								WARWICK	SERVICE PROJECT	RHODE ISLANI
DATE:	02/15/2023	F	REVISION	S	F	REVISION:	S	DRAWING TITLE:		DRAWING NO.
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SHEET:	019								BUS SHELTER PLAN	I C-401

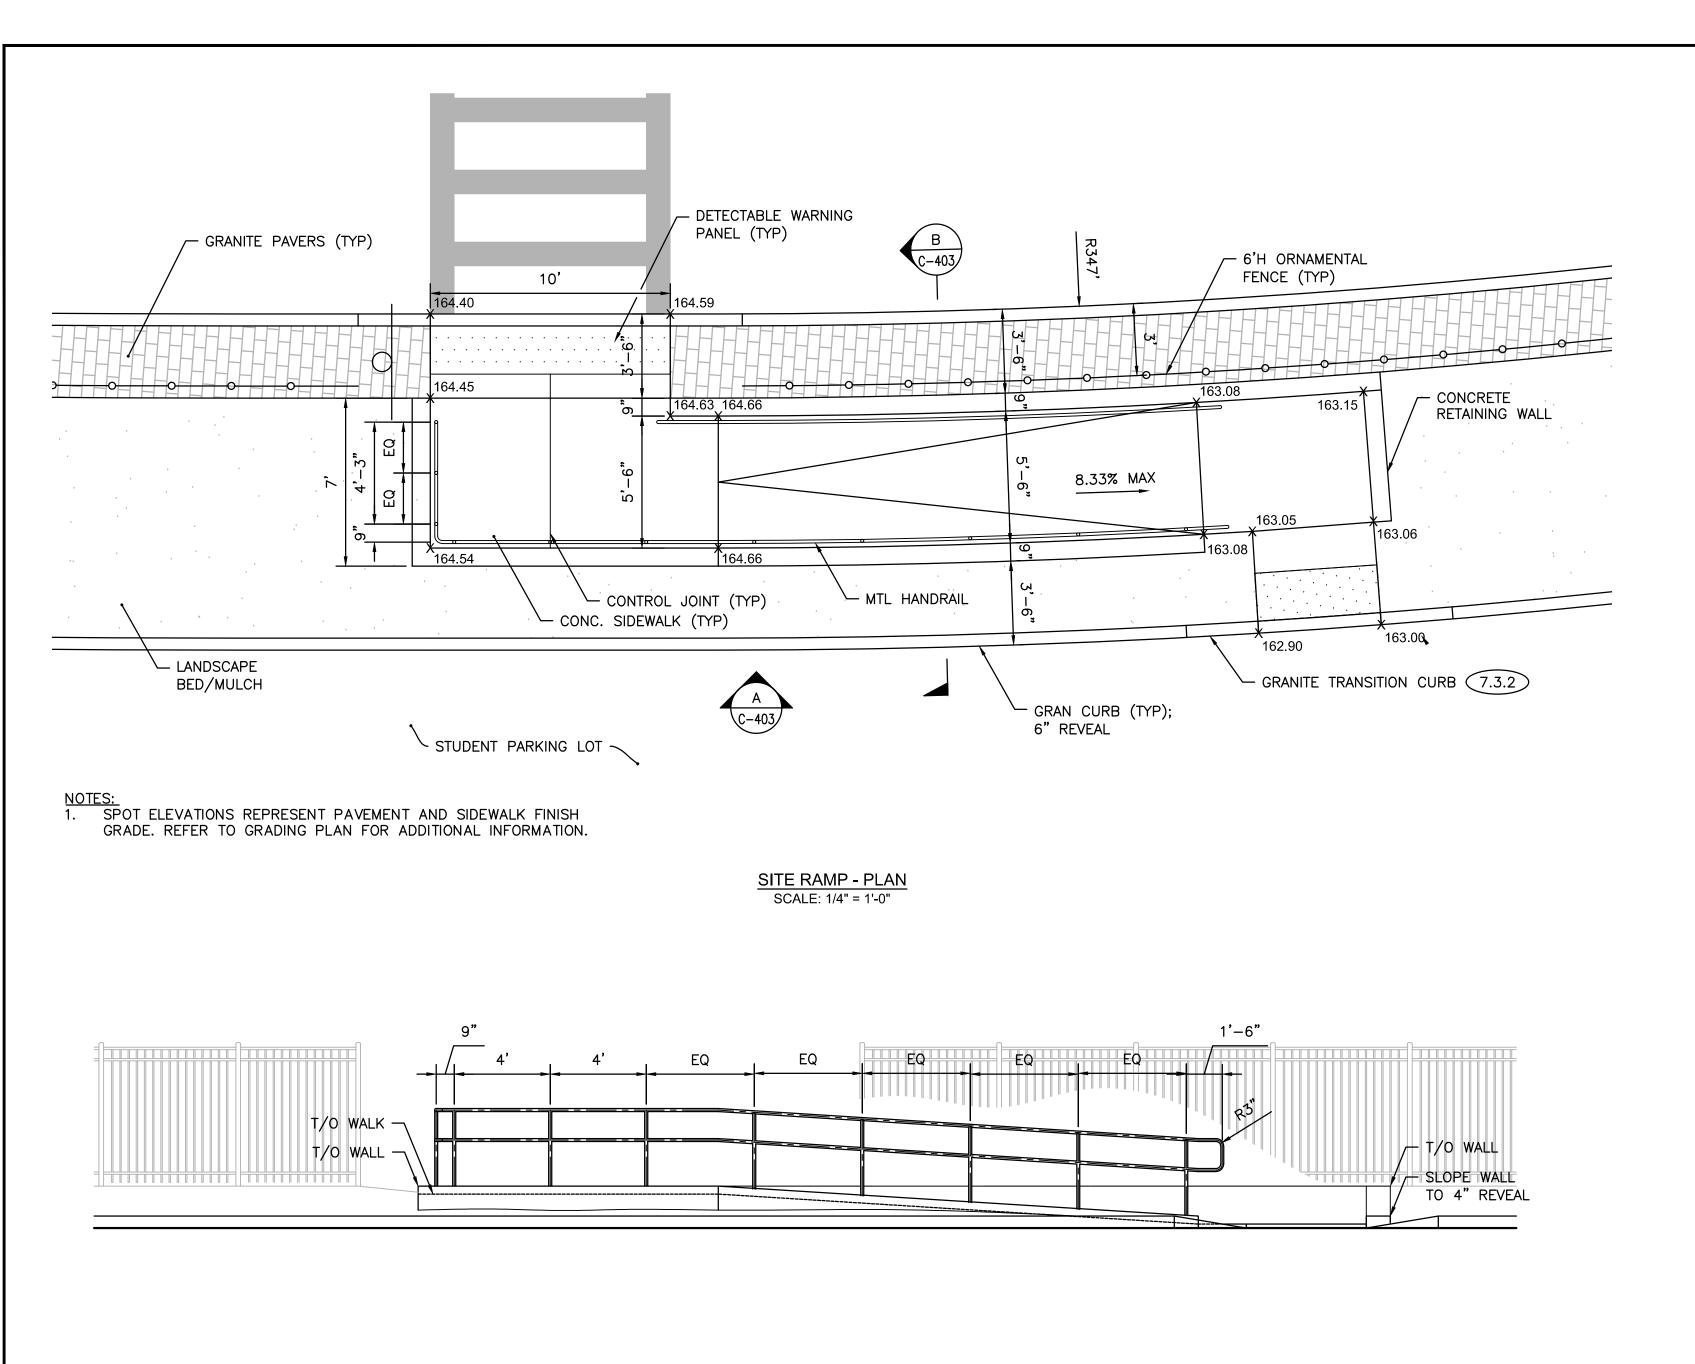

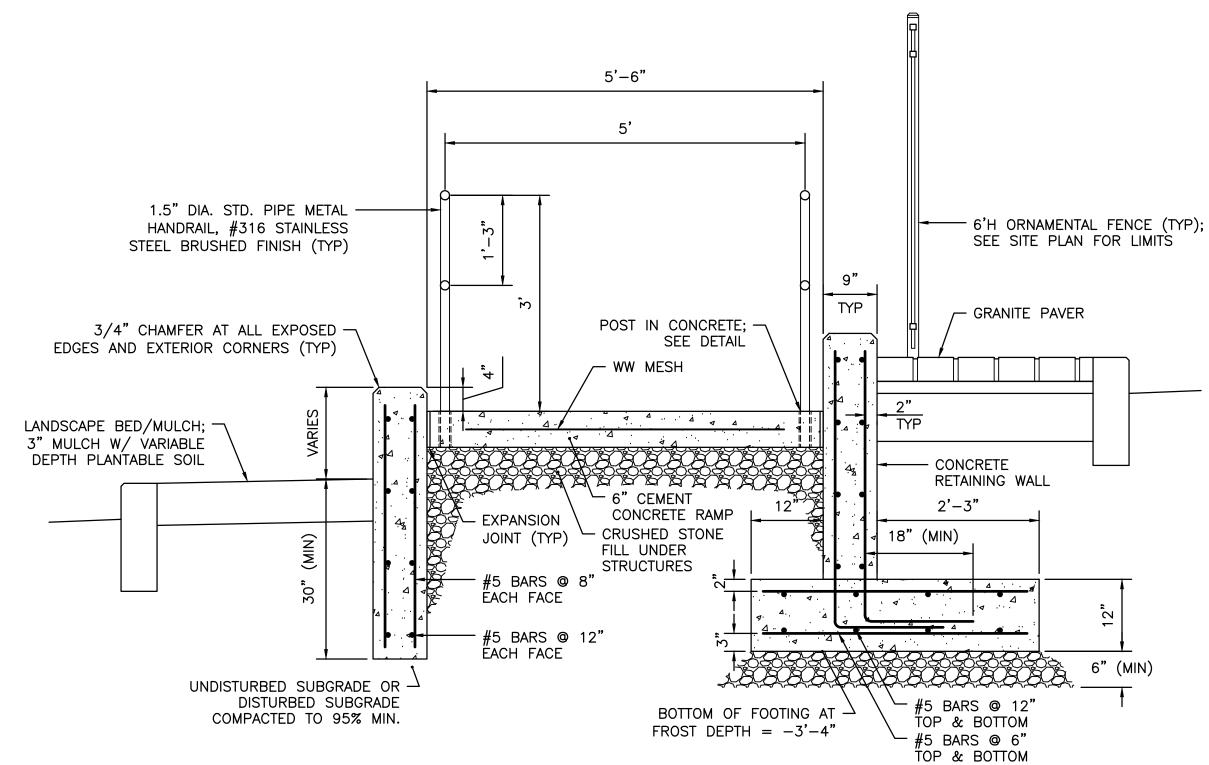

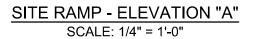

56 Exchange Terrace


Providence, RI 02903

5' (MAX) POST SPACING, TYP. / WALKING SURFACE SEE PLANS TOP LANDING RAMP BOTTOM LANDING

NOTES: 1. ALL WELDS TO BE TO TYPE I CONTINUOUS

2. LANDING LENGTH SHALL BE 60" MINIMUM AND WIDTH SHALL BE AT LEAST AS WIDE AS THE WIDEST RAMP RUN LEADING TO THE LANDING. SLOPES AT LANDINGS STEEPER THAN 2% SHALL NOT BE PERMITTED.

SITE RAMP - SECTION "B" SCALE: 3/4" = 1'-0"

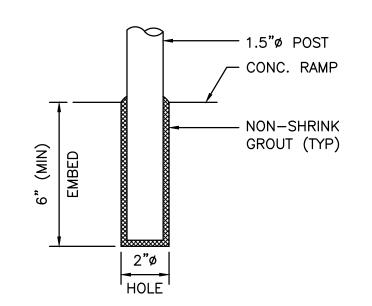

- NOTES:

 1. EXTEND POSTS 6" INTO THICKENED EDGE OF CONCRETE SIDEWALK, CONCRETE SLAB, TOP OF WALL OR CONCRETE FOOTING
- 2. CORE DRILL OPENINGS SO THAT INSIDE DIAMETER OF POST OPENING IS 1/2" LARGER THAN OUTSIDE DIAMETER OF POST.
- 3. COAT END OF PIPE WITH ZINC CHROMATE PRIMER OR HEAVY BITUMINOUS PAINT TO PROTECT AGAINST ACCELERATED CORROSION.
- 4. POST TO BE SET IN NON-SHRINK, NON-METALLIC GROUT.


RAMP HANDRAIL SCALE: 3/4" = 1'-0"


POST IN CONCRETE SCALE: 3" = 1'-0"


4th Floor, Suite 400 (401) 824-3600 INTERNATIONAL MBAKERINTL.COM



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CHECKED								WARWICK	SERVICE PROJECT	RHODE ISLANI
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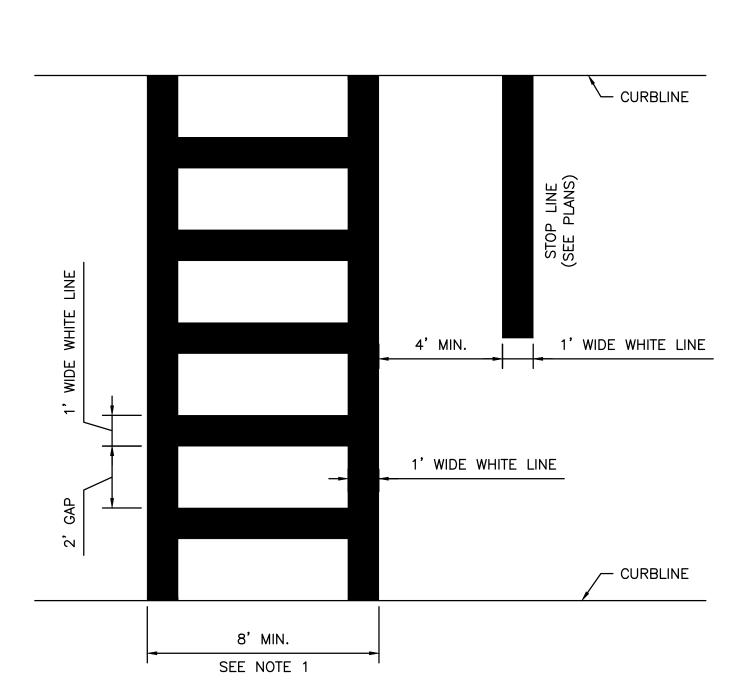


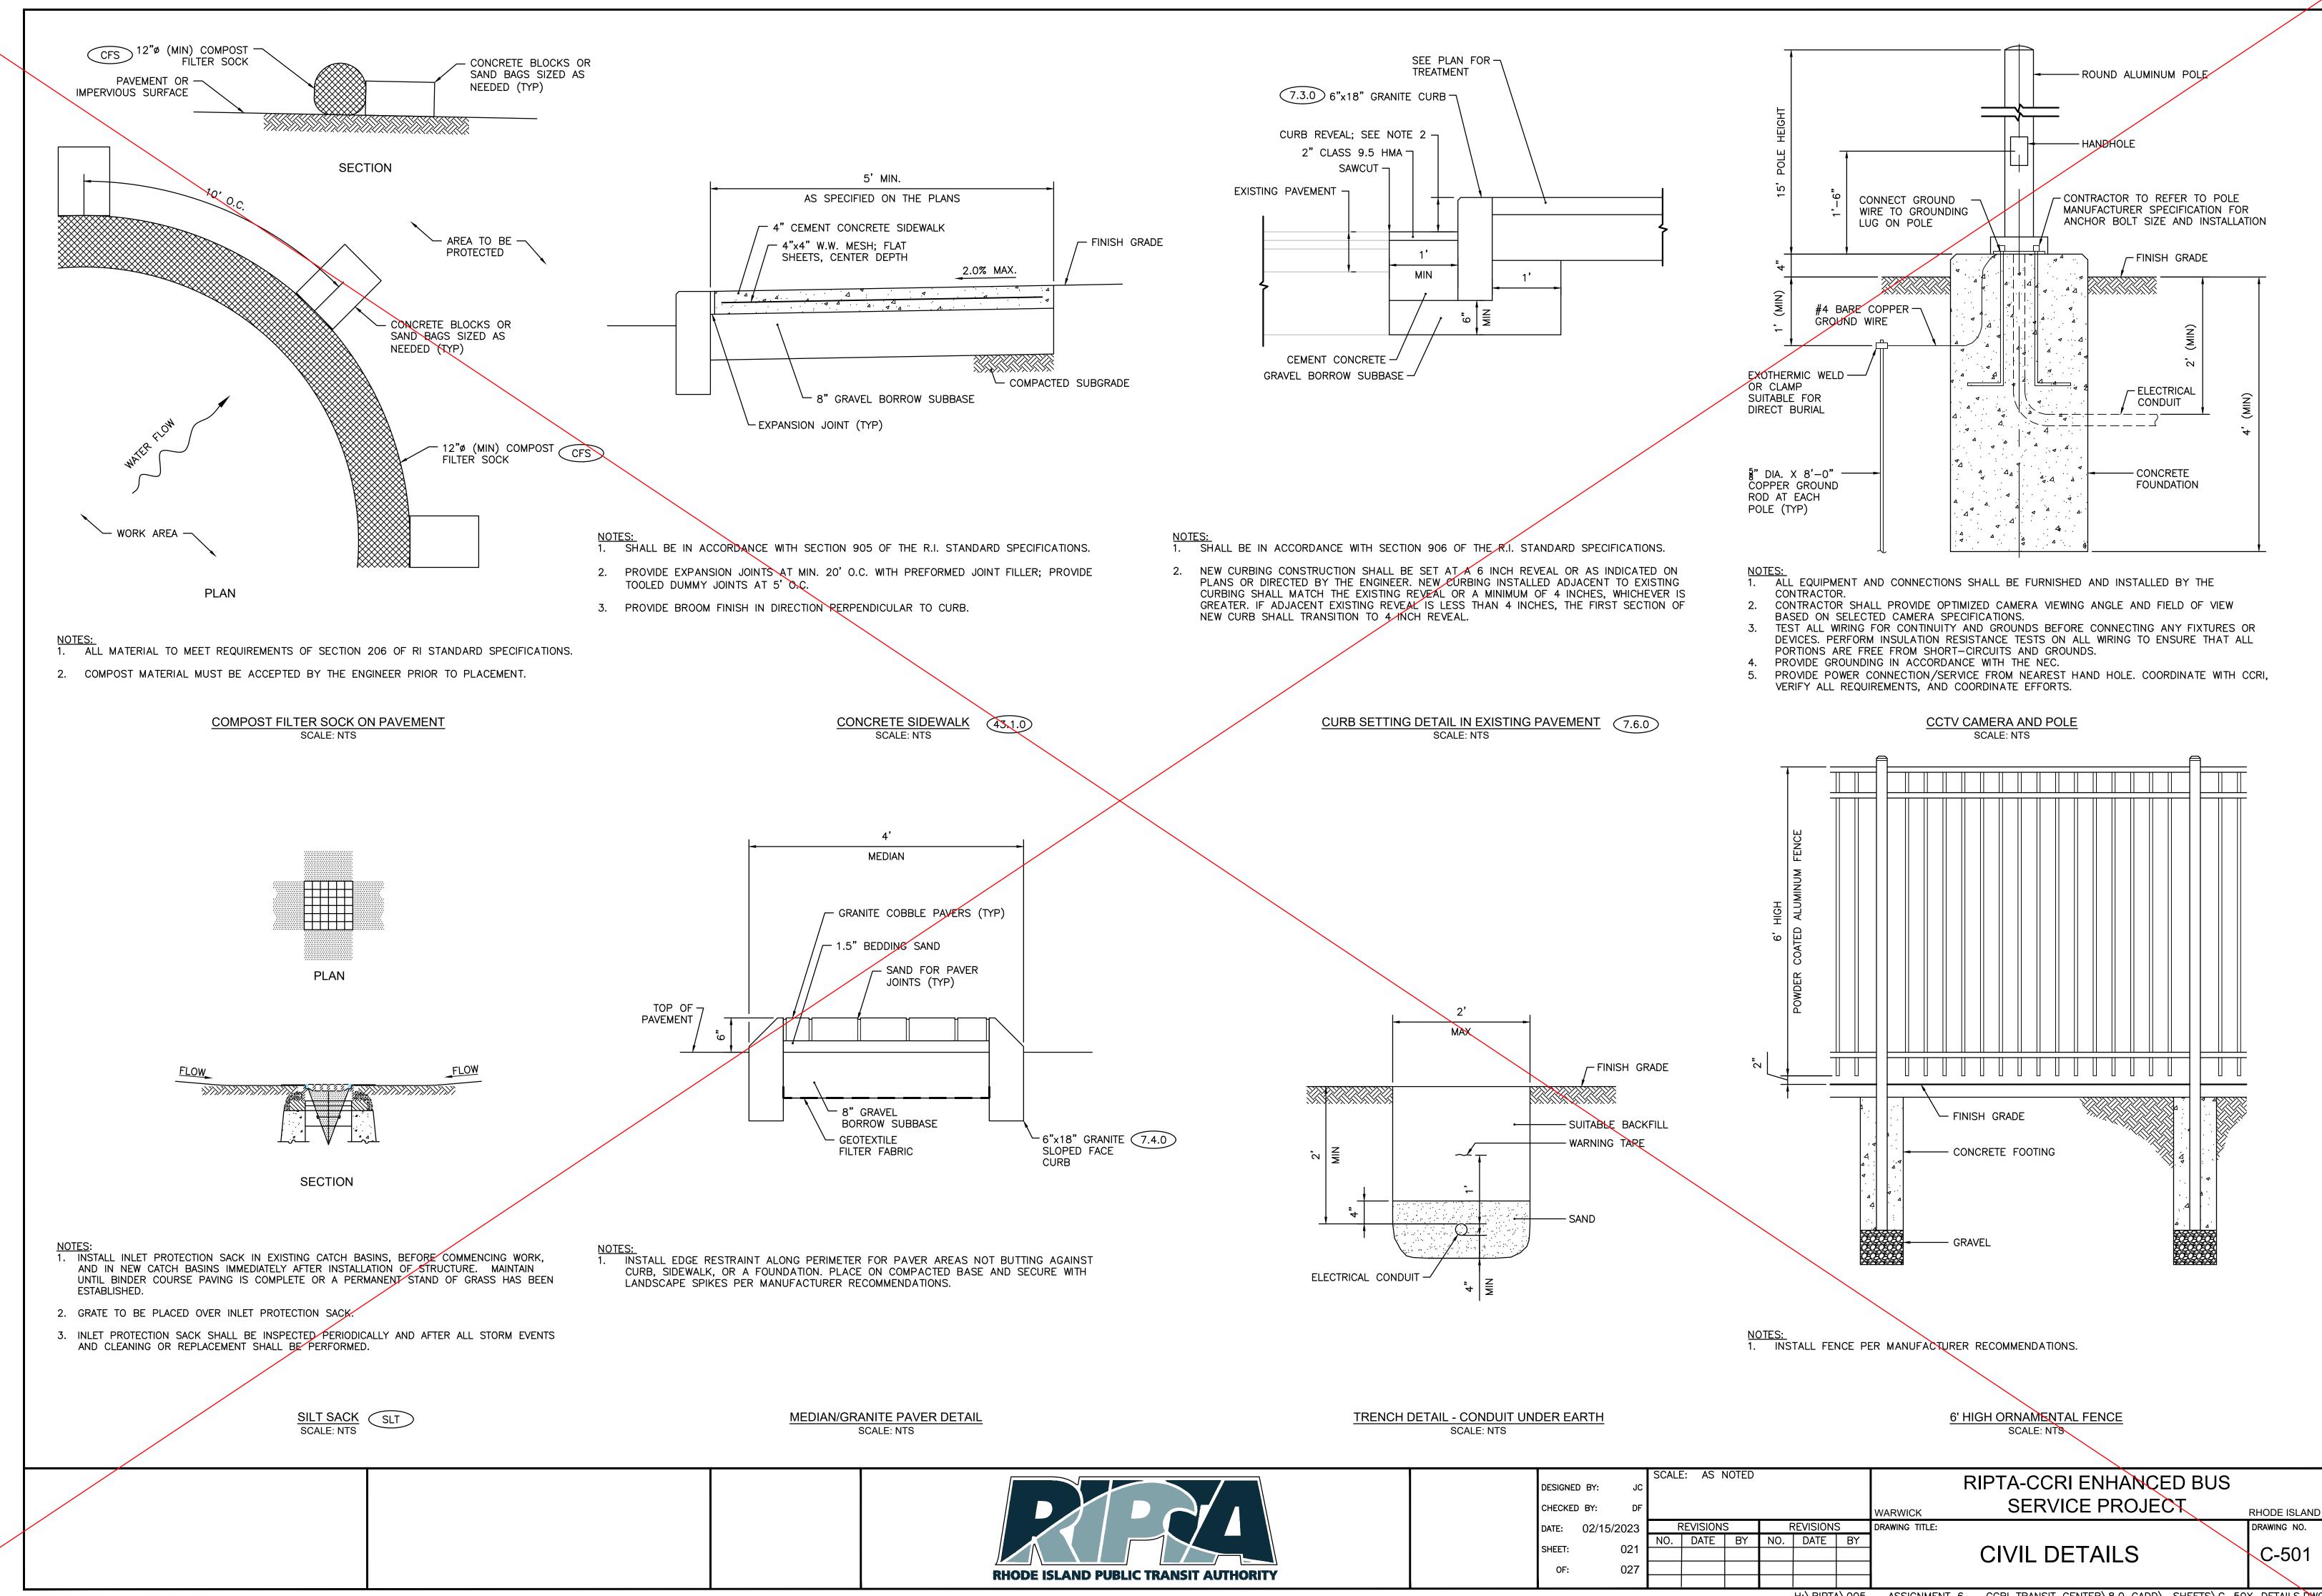NOTES:

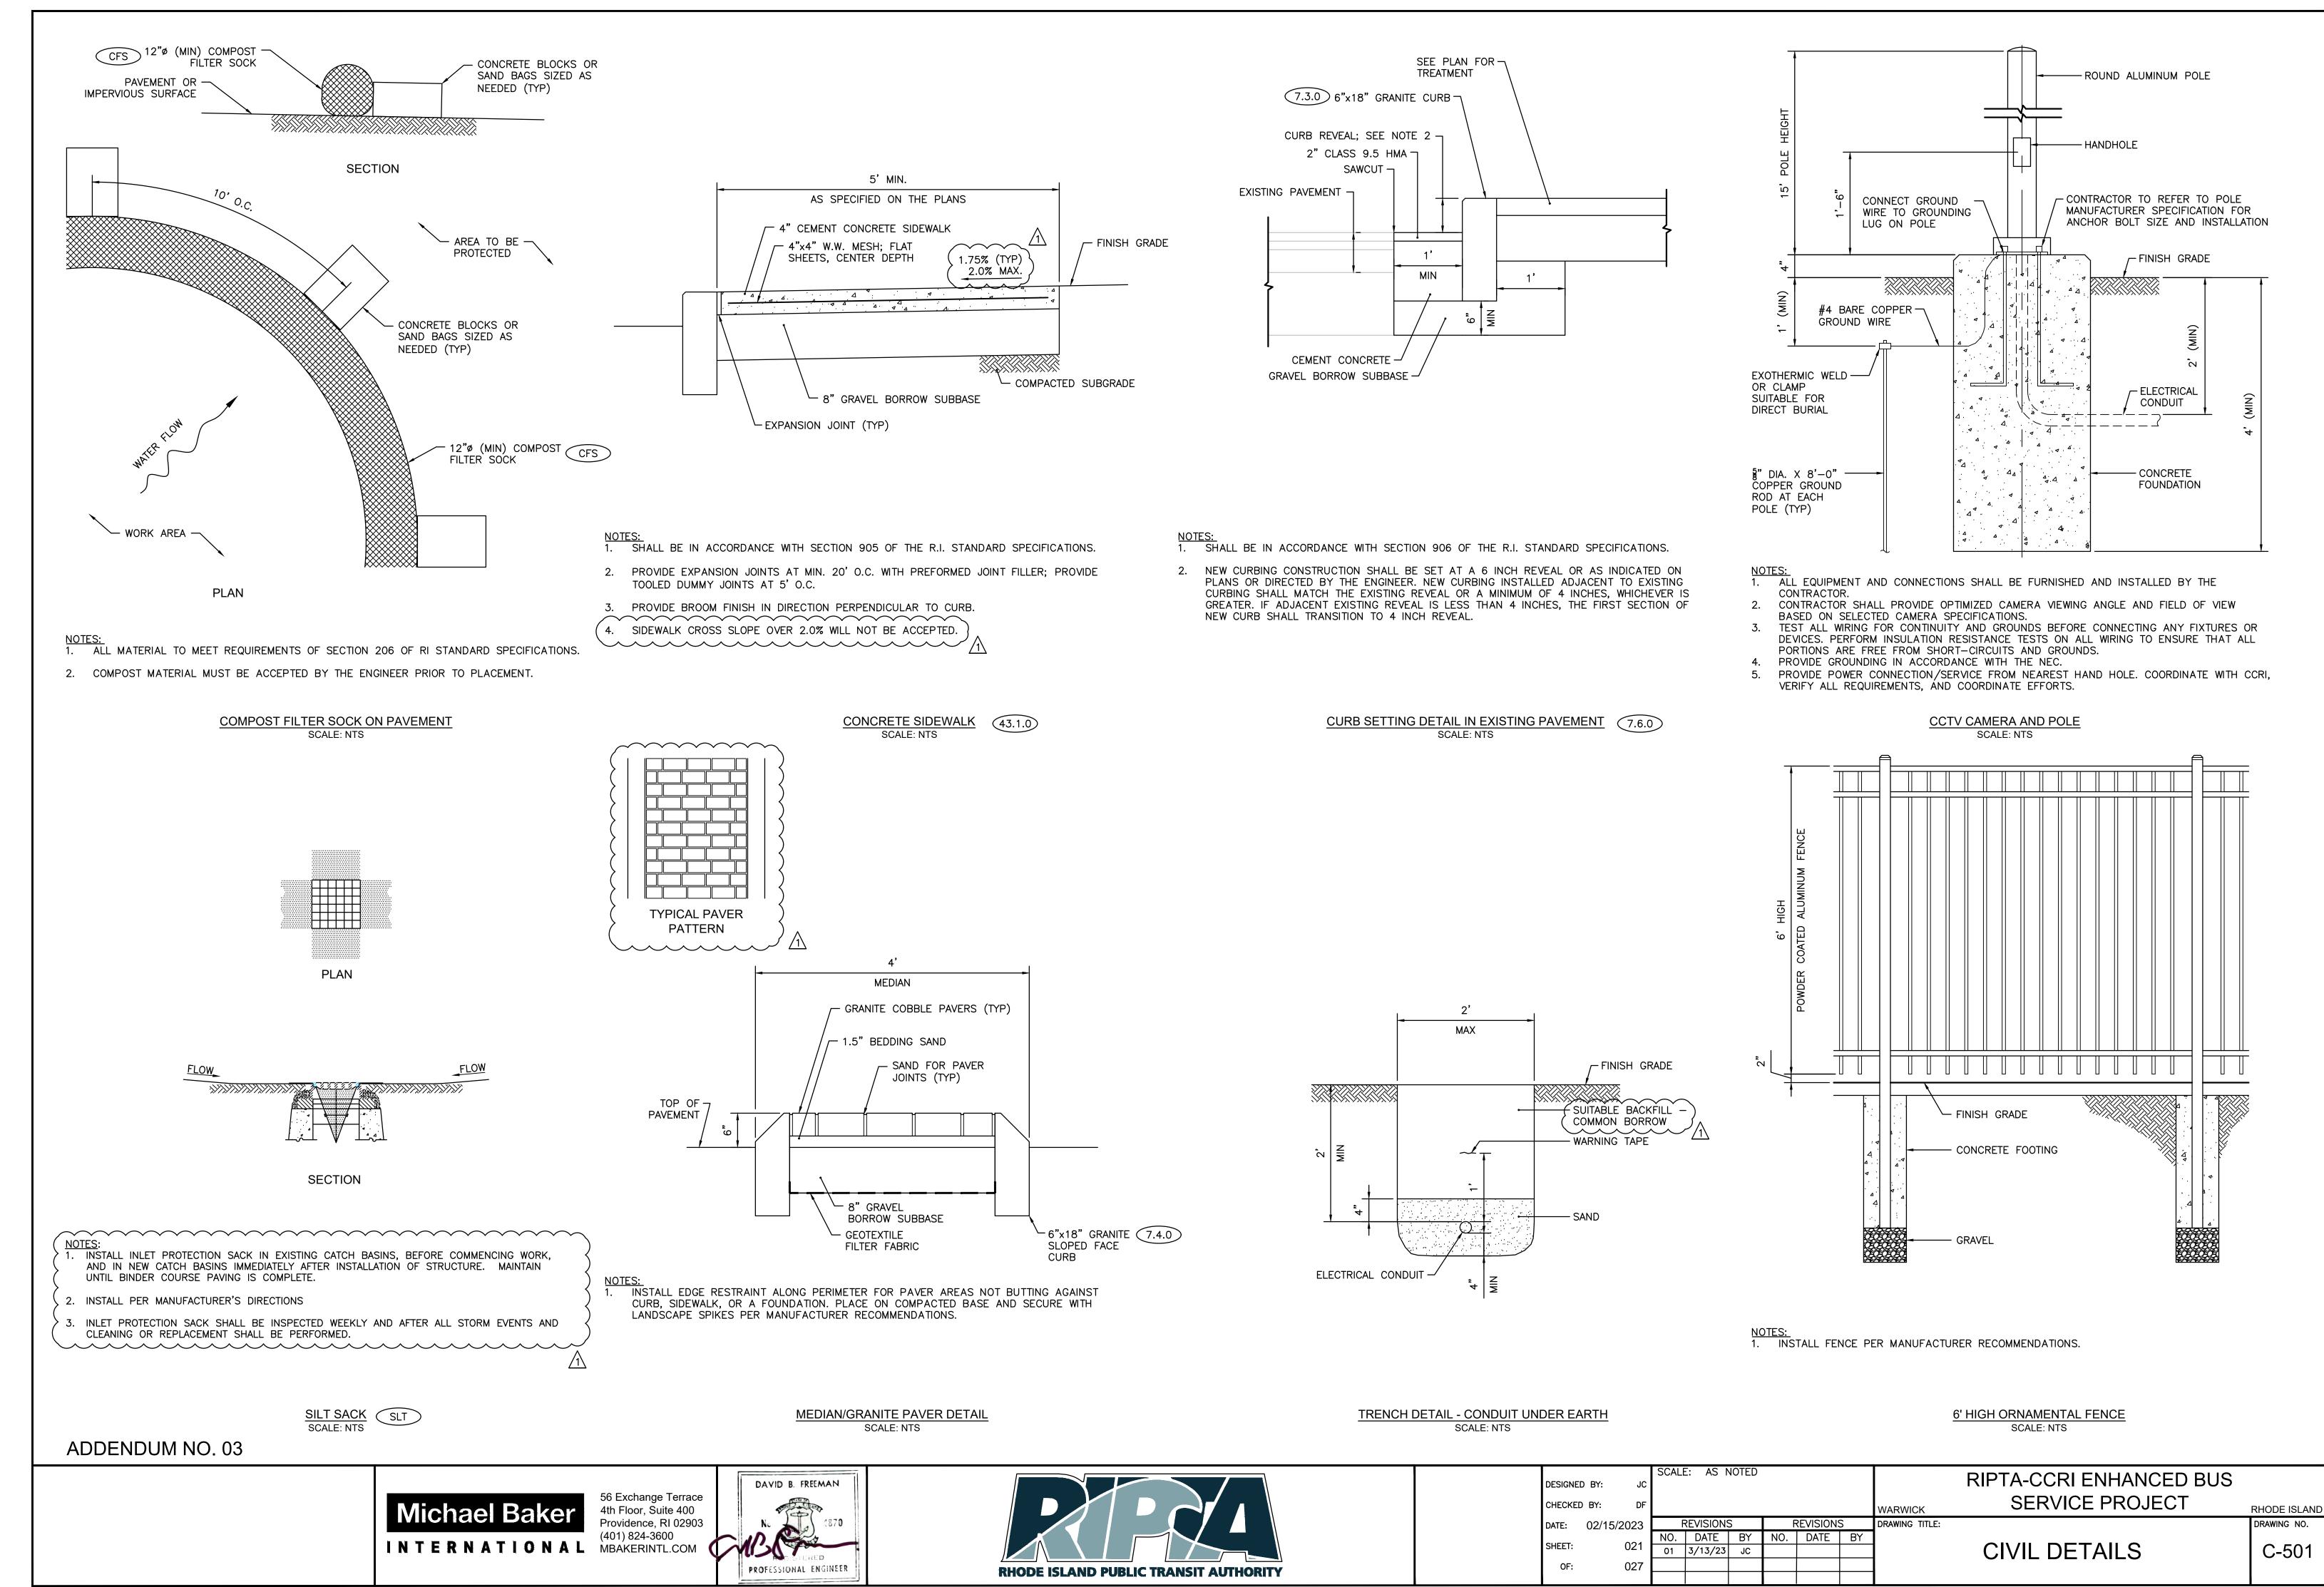1. A CLEAR PATH OF NOT LESS THAN 4-FT SHALL BE PROVIDED IN SIDEWALK AREAS.

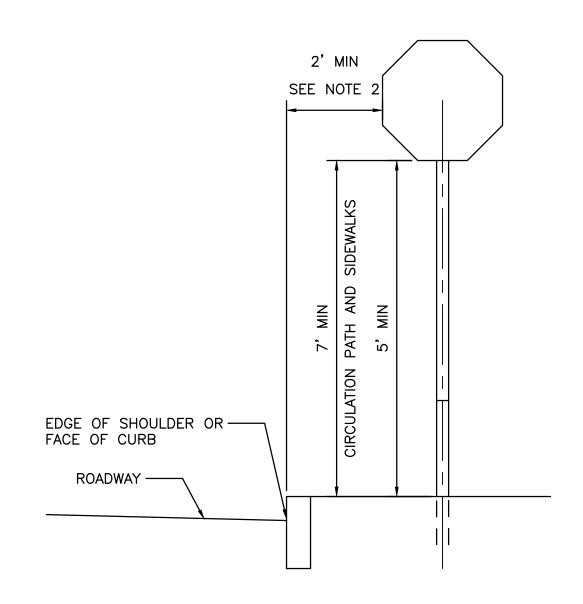
2. A LATERAL OFFSET FROM THE FACE OF CURB MAY BE USED WHERE SIDEWALK WIDTH IS LIMITED OR WHERE EXISTING UTILITY POLES ARE CLOSE TO THE CURB.

TYPICAL SIGN PLACEMENT DETAIL SCALE: NTS



1. CROSSWALK WIDTH SHALL BE 8'-0" UNLESS OTHERWISE CALLED FOR ON THE PLANS.


- 2. LONGITUDINAL CROSSWALK LINES TO BE PARALLEL TO CURBLINE.
- 3. ALL LONGITUDINAL CROSSWALK LINES TO BE THE SAME LENGTH AND PROPERLY ALIGNED.

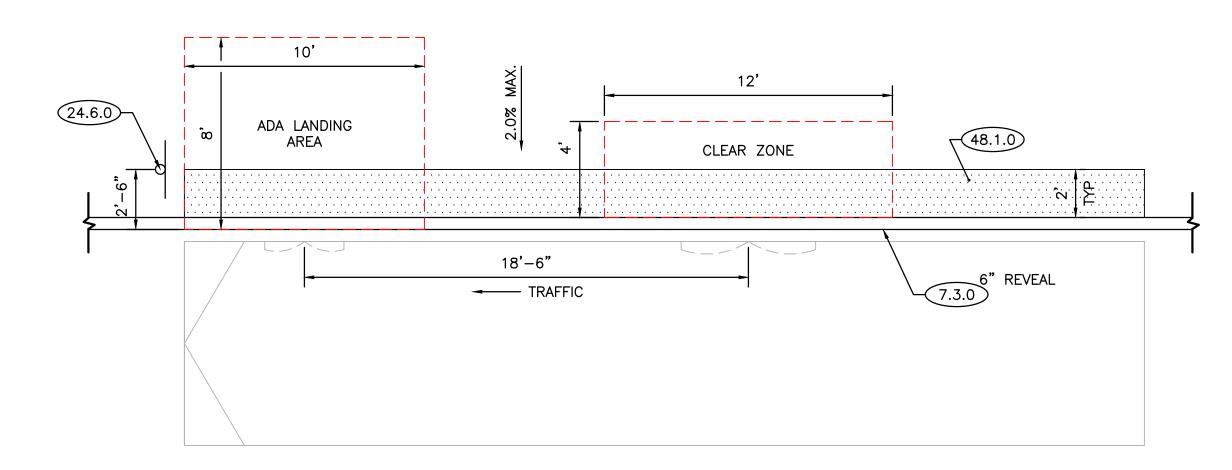

NOTES: 1. ADA LANDING AREA SHALL BE A FIRM, STABLE SURFACE, WITH A MAXIMUM 2% CROSS SLOPE.

- 2. LANDING AREA AND CLEAR ZONE SHALL REMAIN CLEAR FROM VERTICAL ELEMENTS.
- 3. LIMITS OF DETECTABLE WARNING PLANEL (R.I. STD 48.1.0) AS SHOWN ON THE PLANS.

LANDING AREA AND CLEAR ZONE DETAIL BUS STOP LANDINGS SCALE: NTS

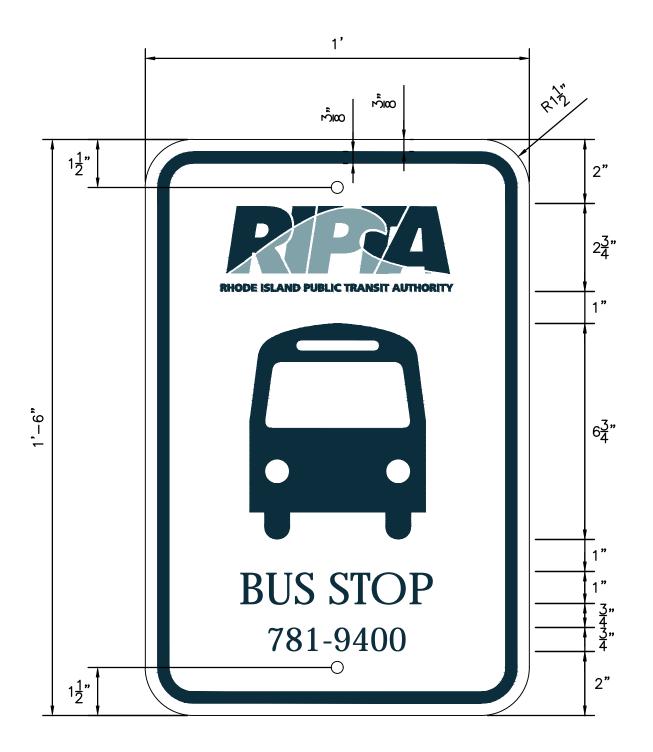


NOTES:

1. COLORS: LEGEND, BORDER — PANTONE PMS #547
RIPTA LOGO — PANTONE PMS #547 & PMS #5493
BACKGROUND — WHITE (RETROREFLECTIVE)

2. FONT: AVANTGARDE BOOK; SIZE AS SHOWN

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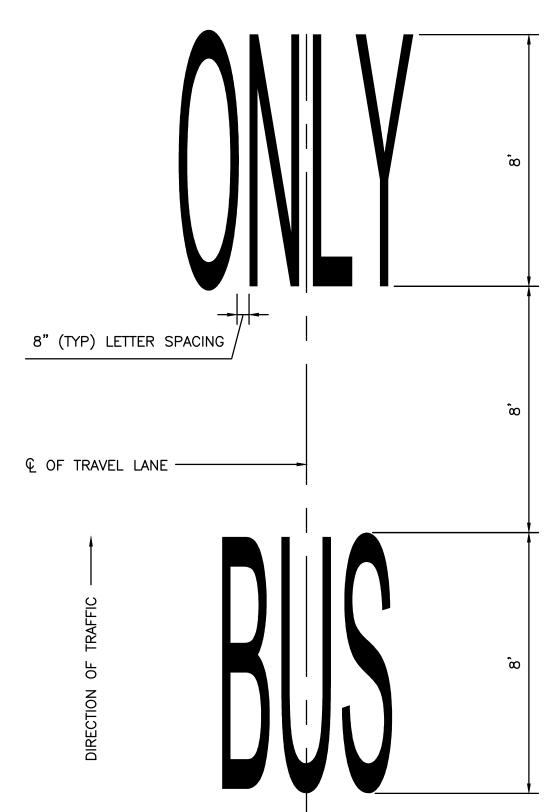


<u>NOTES:</u> 1. COLORS: LEGEND, BORDER — BLACK BACKGROUND - WHITE (RETROREFLECTIVE)

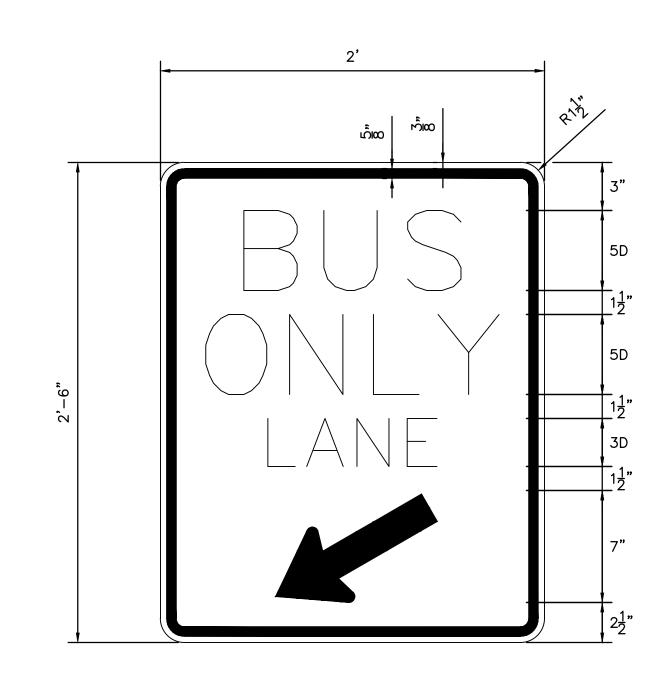2. REFER TO M.U.T.C.D. STANDARD HIGHWAY SIGNS AND MARKINGS BOOK FOR LETTER AND SYMBOL DETAILS.

R3-XXL "BUS ONLY LANE" SIGN

SCALE: NTS




NOTES:

1. WORD PAVEMENT MARKING SHALL CONSIST OF PREFORMED LETTER SHAPES AS SPECIFIED IN THE M.U.T.C.D. STANDARD HIGHWAY SIGNS AND MARKINGS BOOK, PAVEMENT MARKINGS

2. ALL LETTERS SHALL BE SOLID WHITE, UNLESS OTHERWISE SPECIFIED.

BUS ONLY PAVEMENT MARKING

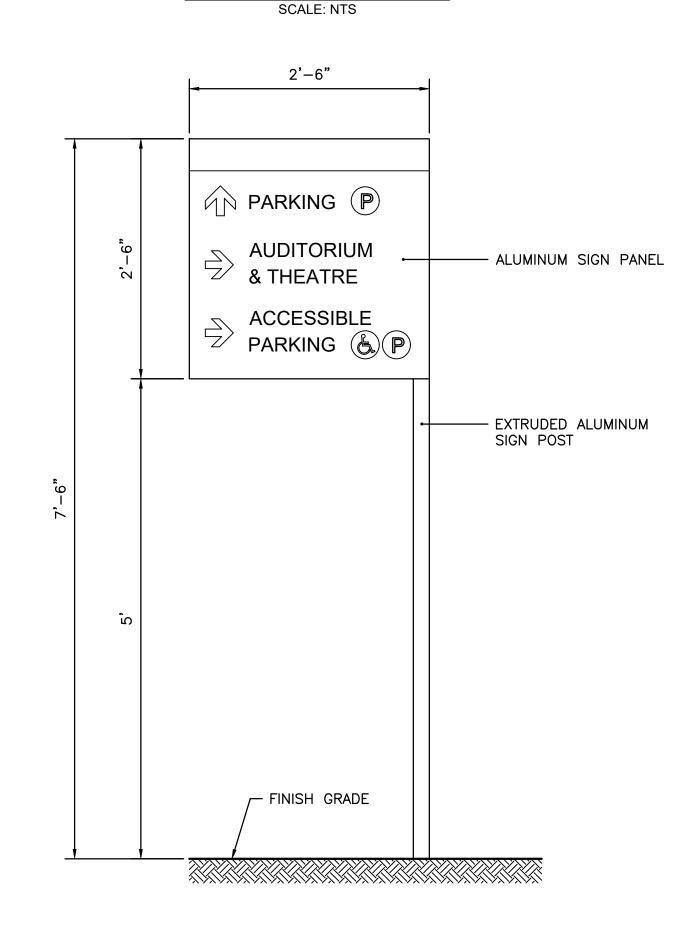

CCRI WAYFINDING SIGN (NIC) SCALE: NTS


CROSSWALK AND STOP LINE SCALE: NTS

RIPTA "BUS STOP" SIGN SCALE: NTS


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DESIGNED	D BY: JC								RIPTA-CCRI ENHANCED BUS	
CHECKED	BY: DF							WARWICK	SERVICE PROJECT	RHODE ISLAND
DATE:	02/15/2023	F	REVISION	S	F	REVISION	S	DRAWING TITLE:		DRAWING NO.
SHEET:	022	NO.	DATE	BY	NO.	DATE	BY		CIVIL DETAILS	C-502





TYPICAL CONCRETE PAVEMENT LAYOUT SCALE: NTS

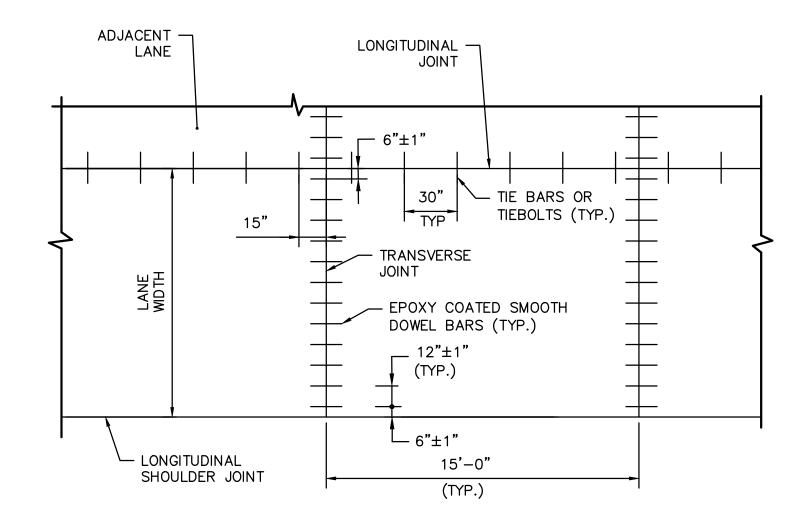

CONCRETE PAVEMENT TO FULL DEPTH BITUMINOUS PAVEMENT TRANSITION SCALE: NTS

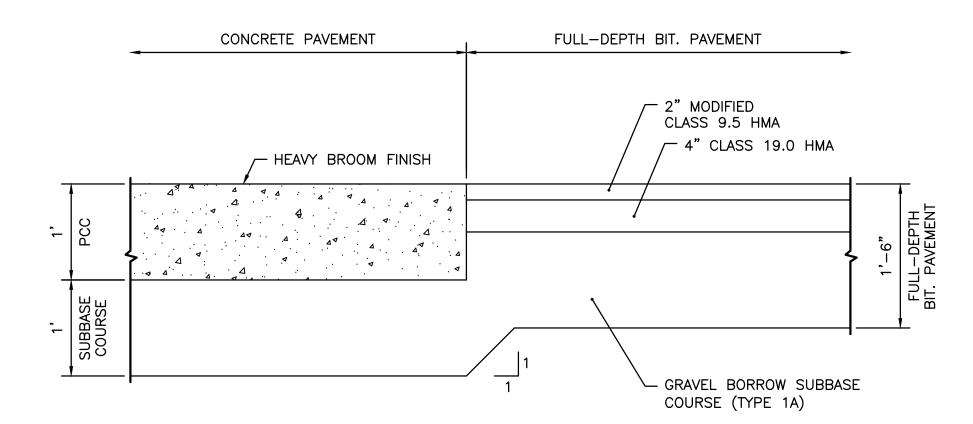


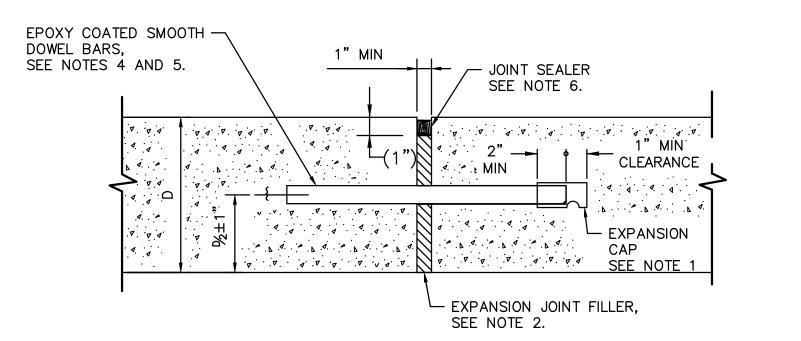


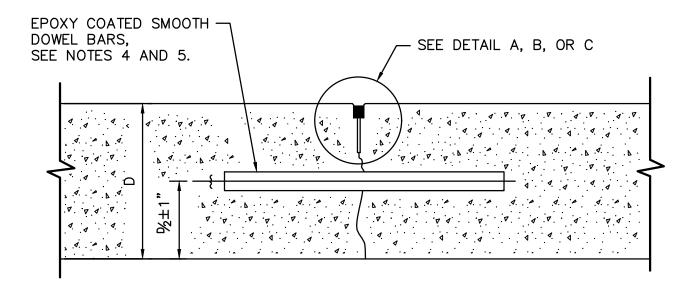

TRANSVERSE EXPANSION JOINT

TRANSVERSE CONTRACTION JOINT

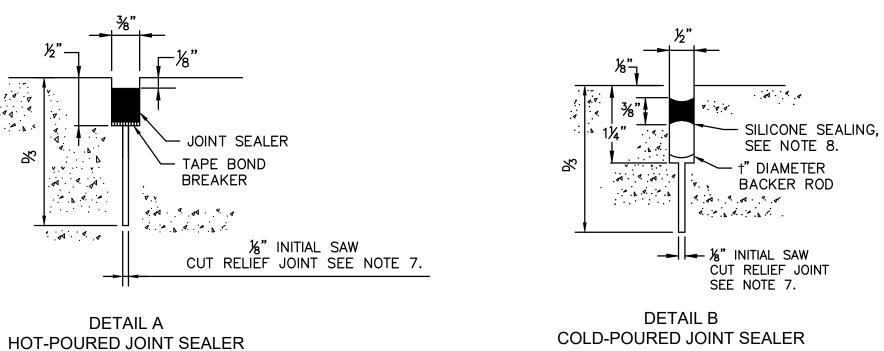

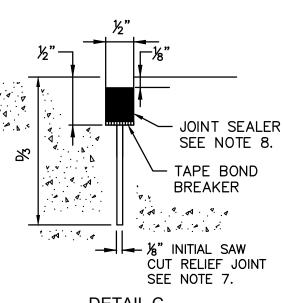


COLD-POURED JOINT SEALER WITH BACKER ROD


DETAIL C COLD-POURED JOINT SEALER WITHOUT BACKER ROD


- 1. PLACE A CLOSED-END EXPANSION CAP OVER THE LUBRICATED END OF ALL DOWEL BARS USED IN TRANSVERSE EXPANSION JOINTS AND PROVIDE A MINIMUM 1" CLEARANCE POCKET ASSURED BY MEANS OF A POSITIVE SPACING DEVICE.
- 2. CUT EXPANSION JOINT FILLER MATERIAL TO CONFORM TO THE CROSS—SECTION OF THE PAVEMENT AND FURNISH IN STRIPS EQUAL TO THE WIDTH OF THE PAVEMENT SLAB. MAKE THE TOP SURFACE SMOOTH AND HAVE HOLES PUNCHED FOR THE DOWEL BARS PROVIDE A SNUG FIT WITHOUT LOSS IN THICKNESS OF THE MATERIAL.
- 3. CONSTRUCT ALL TRANSVERSE JOINTS PERPENDICULAR TO THE CENTERLINE.
- 4. USE MINIMUM 1"øx18" LONG GALVANIZED SMOOTH DOWEL BARS FOR PAVEMENT DEPTHS 10" OR LESS, AND MINIMUM 1½" DIA. SYMB LONG DOWEL BARS FOR PAVEMENT DEPTHS GREATER THAN 10". APPROVED ALTERNATE DOWEL BARS HAVING EQUIVALENT PROPERTIES TO CONVENTIONAL ROUND DOWEL REINFORCEMENT STEEL MAY BE PROPOSED FOR USE.
- 5. PLACE GALVANIZED SMOOTH DOWEL BARS PARALLEL TO THE CENTERLINE AND SURFACE OF THE SLAB.
- 6. MAKE THE TOP OF THE JOINT SEALING MATERIAL \pm $\frac{1}{8}$ " BELOW THE SURFACE OF THE PAVEMENT.
- 7. THE INITIAL SAW CUT RELIEF JOINT IS NOT REQUIRED FOR CONSTRUCTION JOINTS.
- 8. WHEN COLD-POURED JOINT SEALER IS SELECTED FOR USE IN TRANSVERSE JOINTS, USE THE SAME JOINT SEALER IN THE LONGITUDINAL JOINTS.

CONCRETE PAVEMENT JOINTS SCALE: NTS

DESIGNED BY: JC								RIPTA-CCRI ENHANCED BUS						
CHECKED BY: DF								WARWICK SERVIC	CE PROJECT RHODE ISLA	AND				
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OF:	DF: ####							CIVIL DL	TAILS C-30.	J				

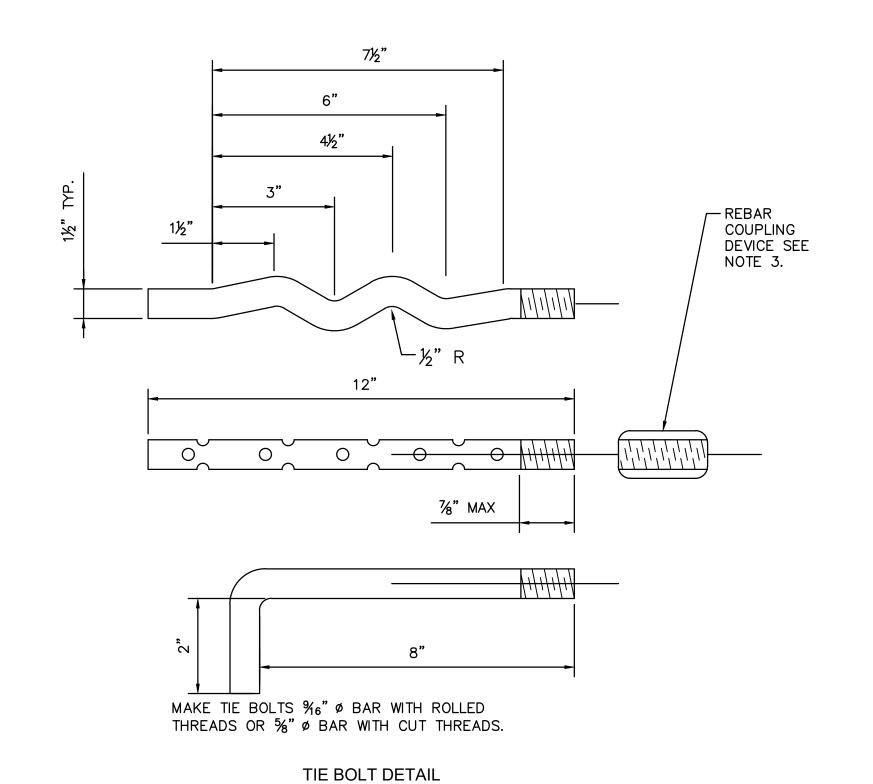


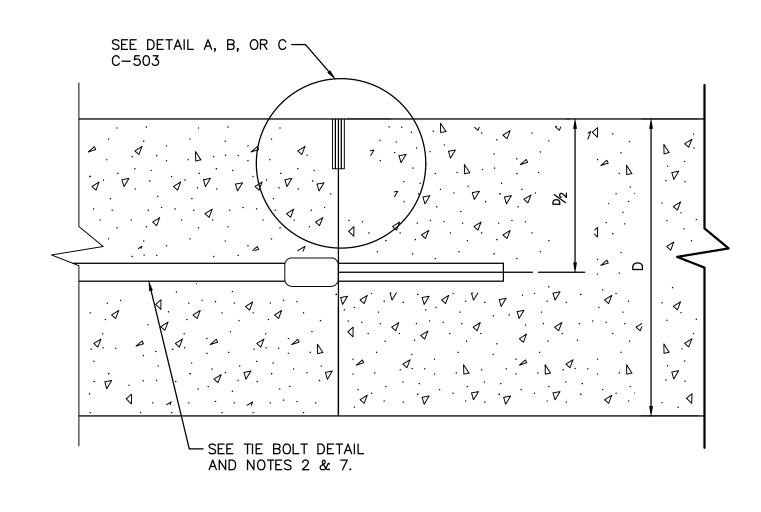


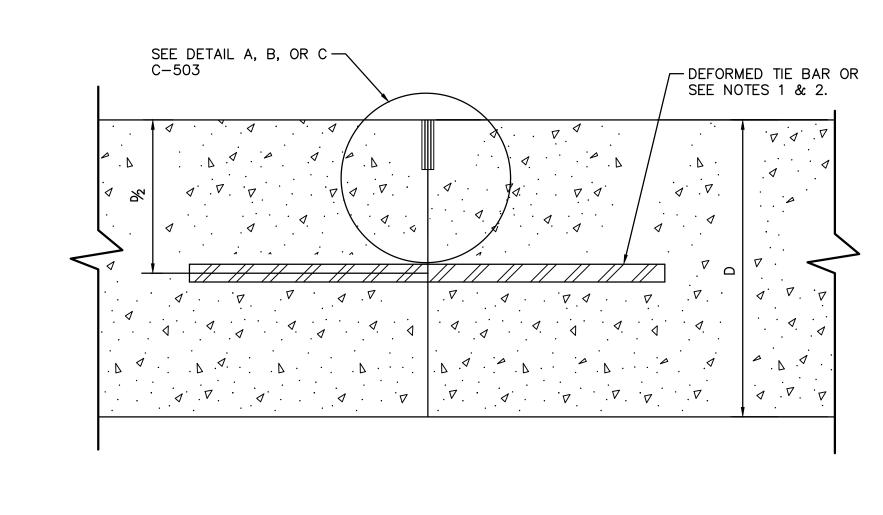

CONSTRUCTION JOINT TIE BOLT



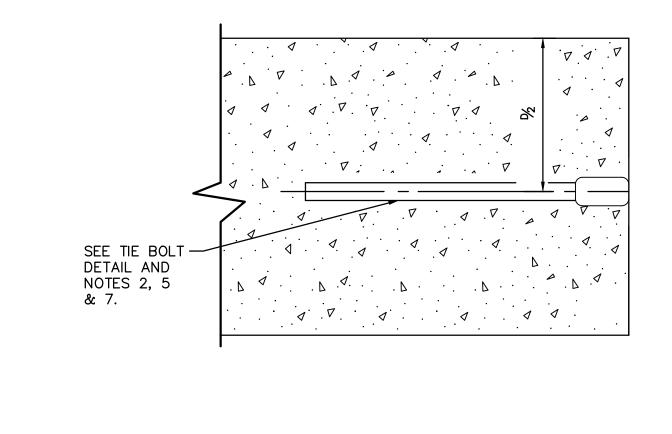

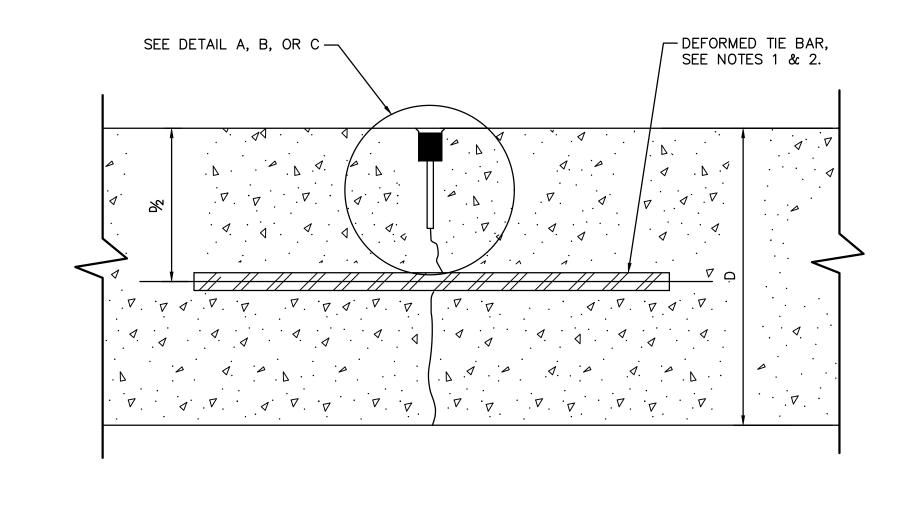

CONTRACTION JOINT

STATIONARY FORMING

. Δ . Δ . . Δ . . Δ . . Δ . . Δ . . . Δ

SEE TIE BOLT

DETAIL AND NOTES 2 & 5.

1. SPECIFY #6 TIE BARS 30"± LONG, SPACED 30" CENTER TO CENTER MAXIMUM. FOR JOINT TIES SPECIFY #6 BARS 18"± LONG, SPACED 30" CENTER TO CENTER MAXIMUM. PLACE PERPENDICULAR TO AND CENTERED OVER THE LONGITUDINAL JOINT 1". WHEN ADJOINING TO AN UNEQUAL PAVEMENT OR SHOULDER DEPTH, D IS THE DEPTH OF THE THINNER SECTION.


SLIP FORMING


2. DO NOT FIELD BEND TIE BARS, TIE BOLTS, AND JOINT TIES.


— SEE NOTE 4.


- 3. USE REBAR COUPLING DEVICE THAT IS LISTED IN THE RIDOT APPROVED MATERIALS LIST.
- 4. TEMPORARILY SECURE THE TIE BOLT TO THE FORM DURING PLACEMENT OF THE CONCRETE USING A METHOD ACCEPTABLE TO THE RE.
- 5. PLACE TIE BOLTS AT 30" CENTER TO CENTER MAXIMUM SPACING. WHEN ADJOINING TO AN UNEQUAL PAVEMENT OR SHOULDER DEPTH, D IS THE DEPTH OF THE THINNER SECTION. SCREW TIE BOLTS UNTIL SNUG.
- 6. USE AN APPROVED EPOXY GROUT MATERIAL TO WITHSTAND THE NECESSARY MINIMUM PULL—OUT RESISTANCE. DRILL TIE BAR HOLE IN EXISTING PAVEMENT ACCORDING TO THE MANUFACTURER'S RECOMMENDATION. USE ROTARY IMPACT DRILL TO AVOID IMPACTING FINES TO HOLE.
- 7. DO NOT USE THE HOOK COMPONENT OF THE TIE BOLT ASSEMBLY WHEN SLIP FORMING.
- 8. WHEN COLD-POURED JOINT SEALER IS SELECTED FOR USE IN TRANSVERSE JOINTS, USE THE SAME JOINT SEALING MATERIAL IN THE LONGITUDINAL JOINTS.


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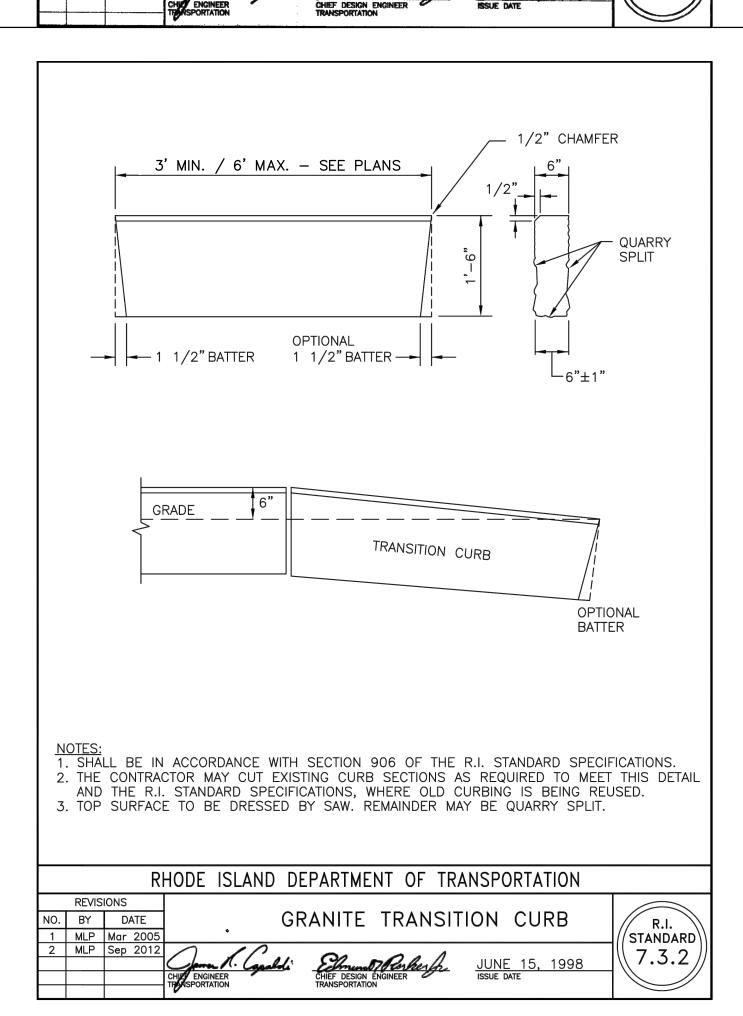


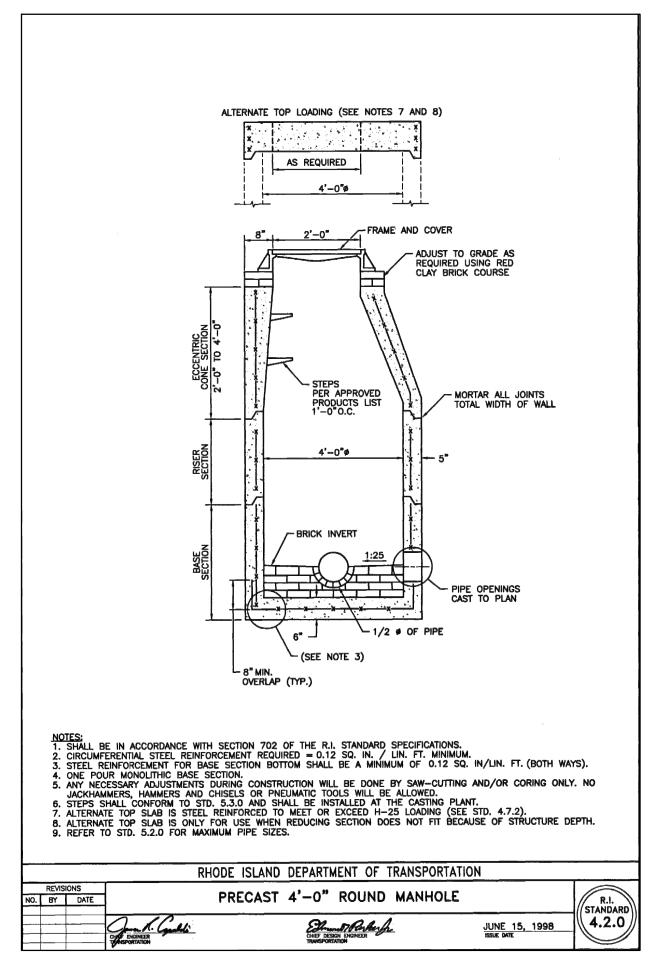


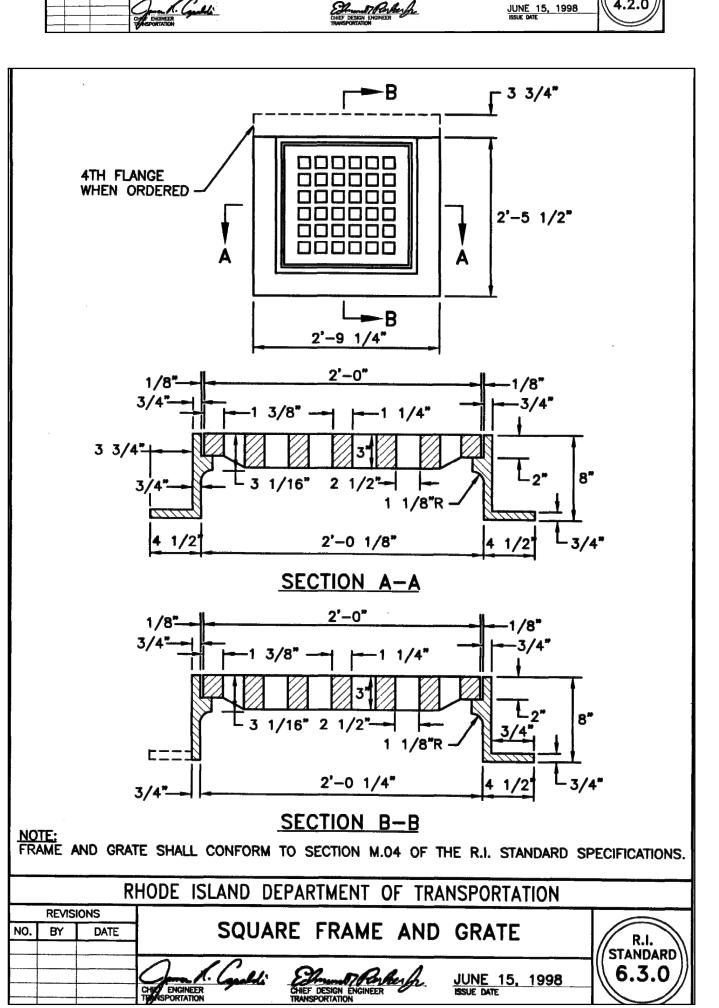


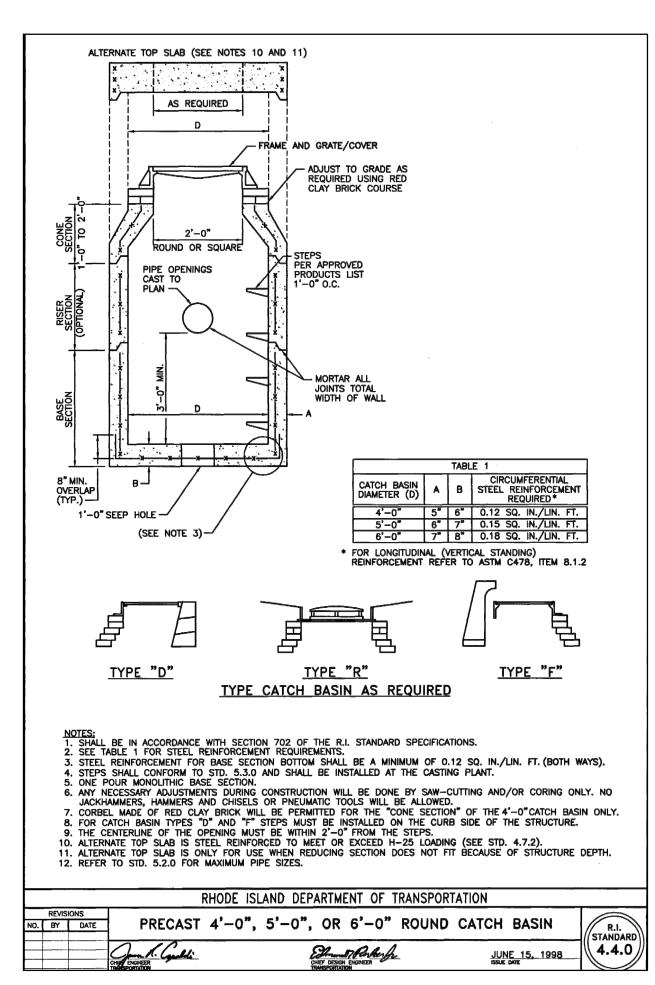

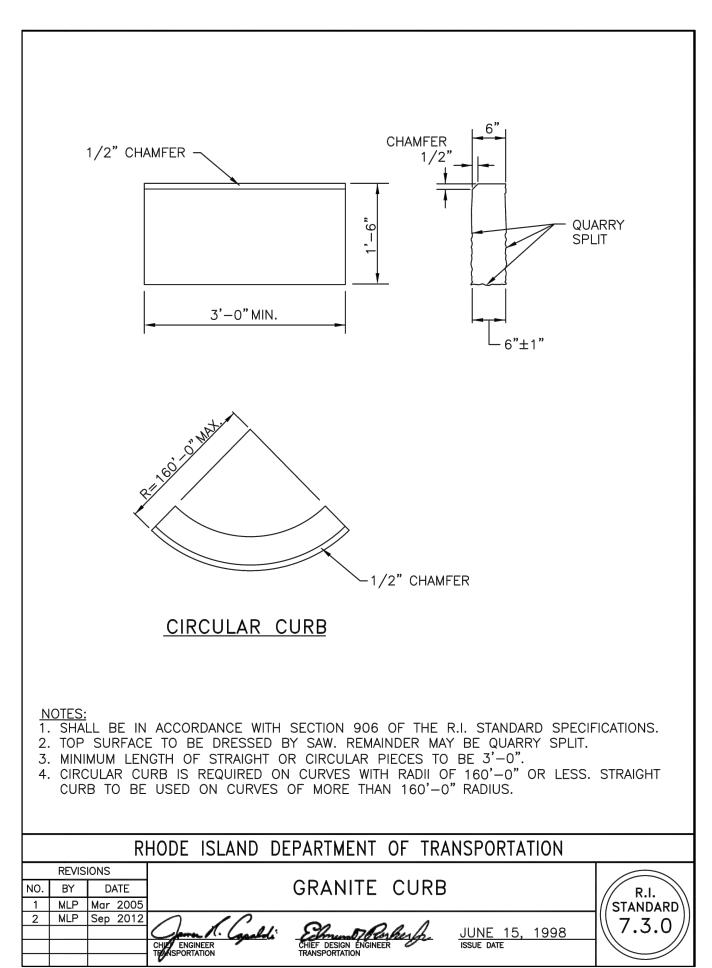

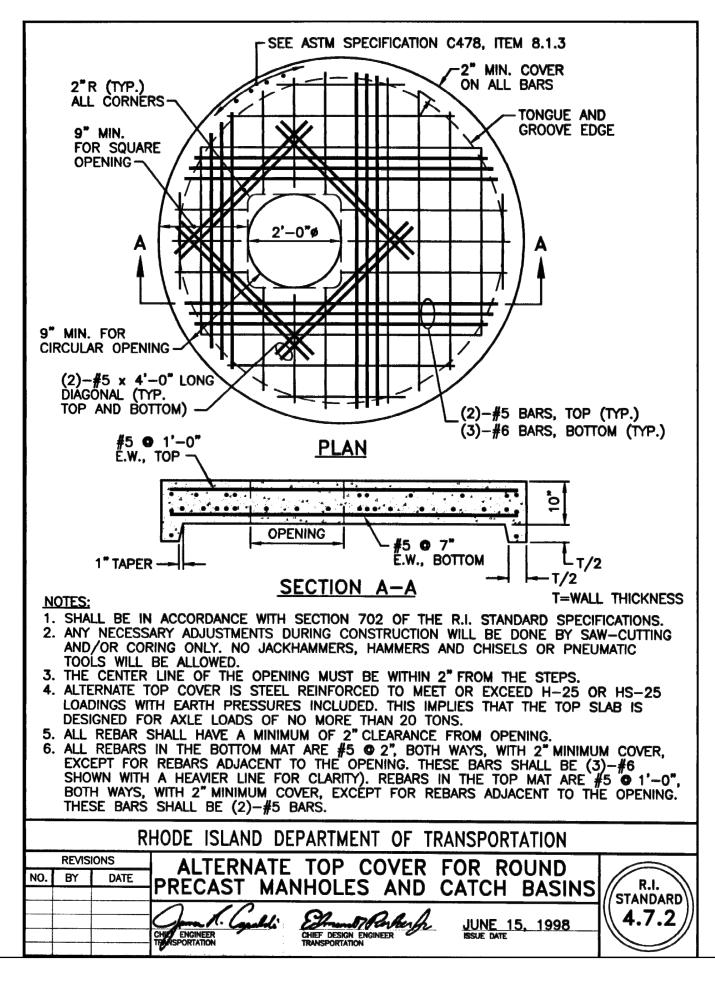


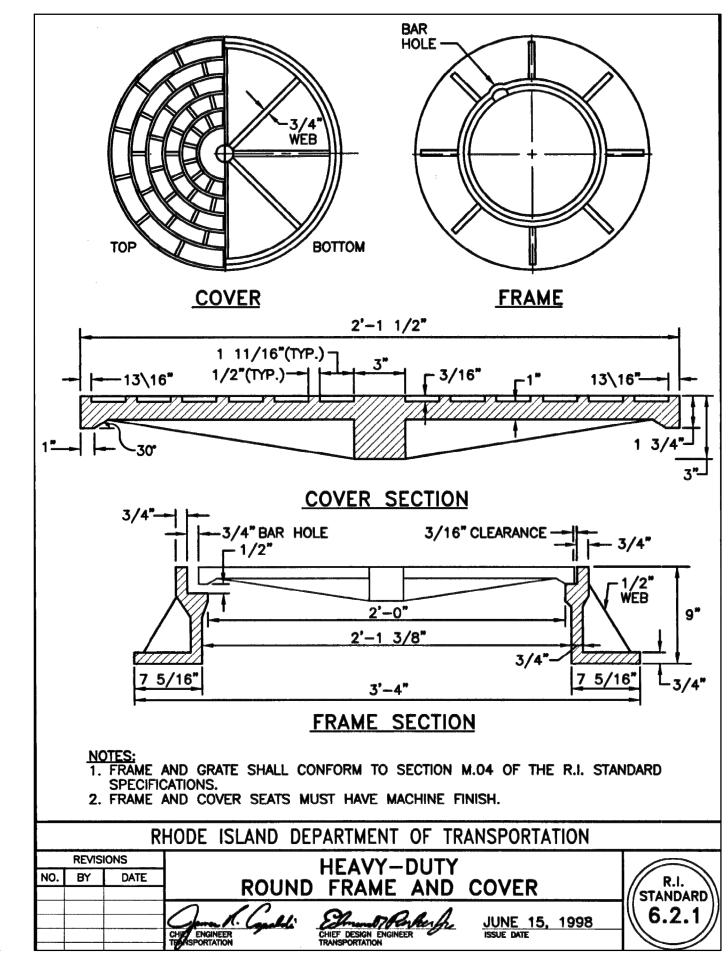


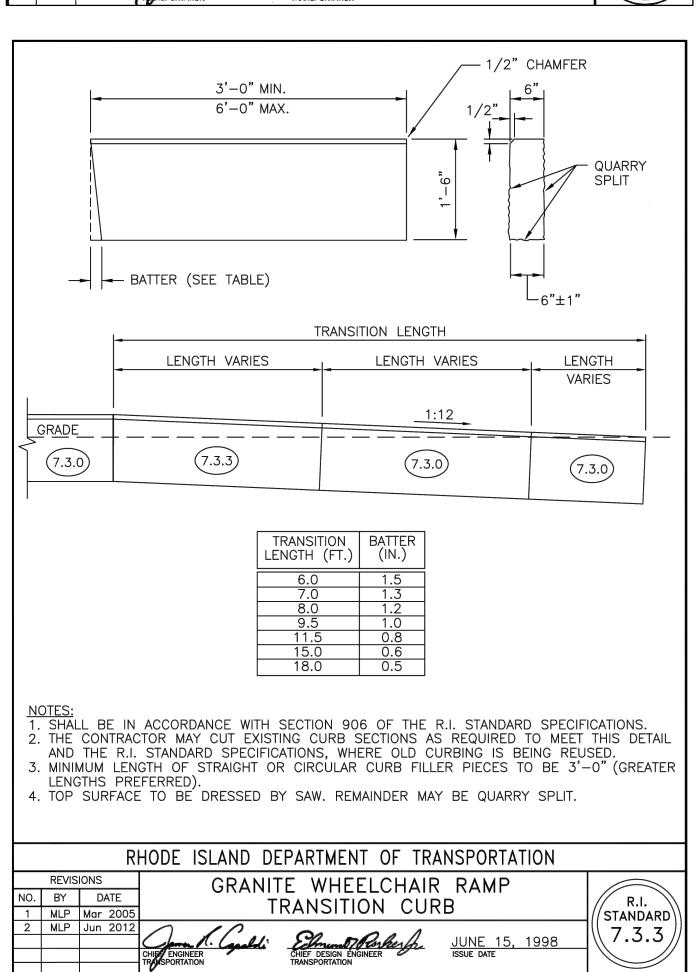








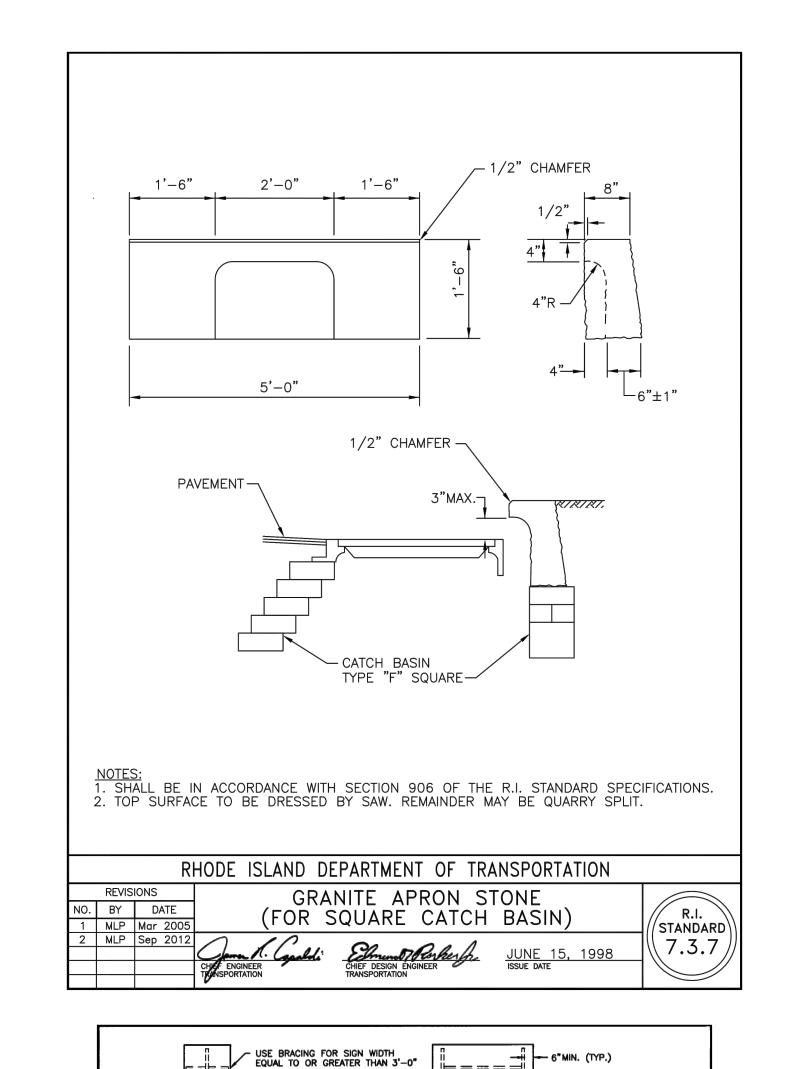


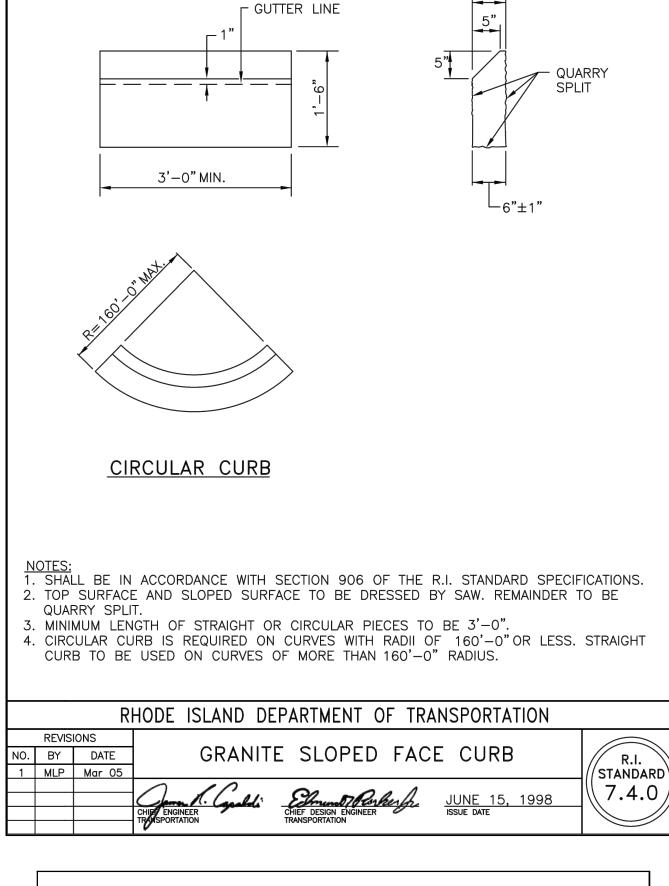


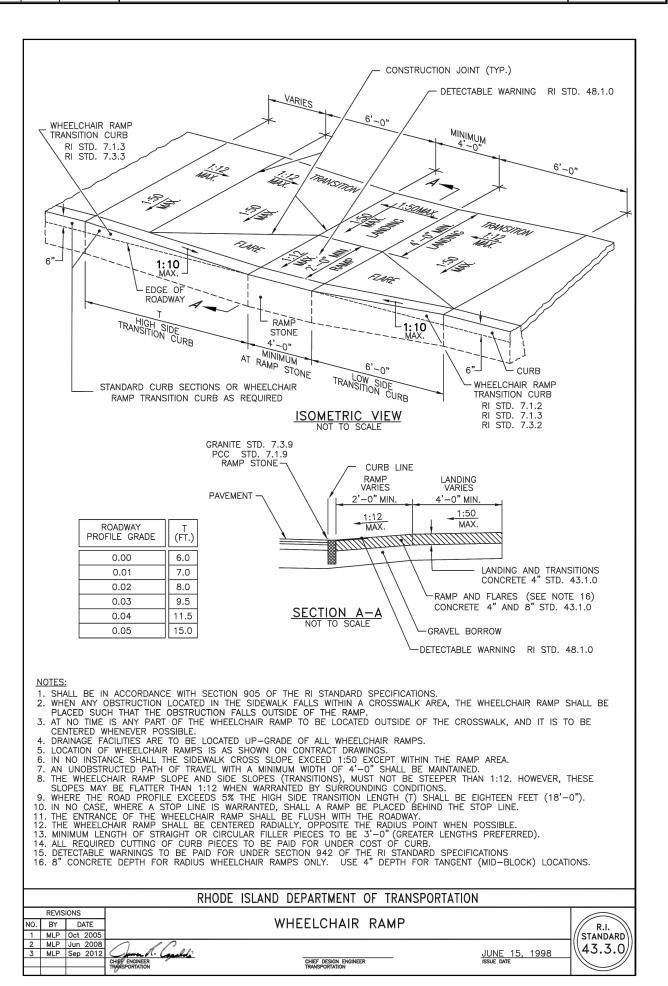


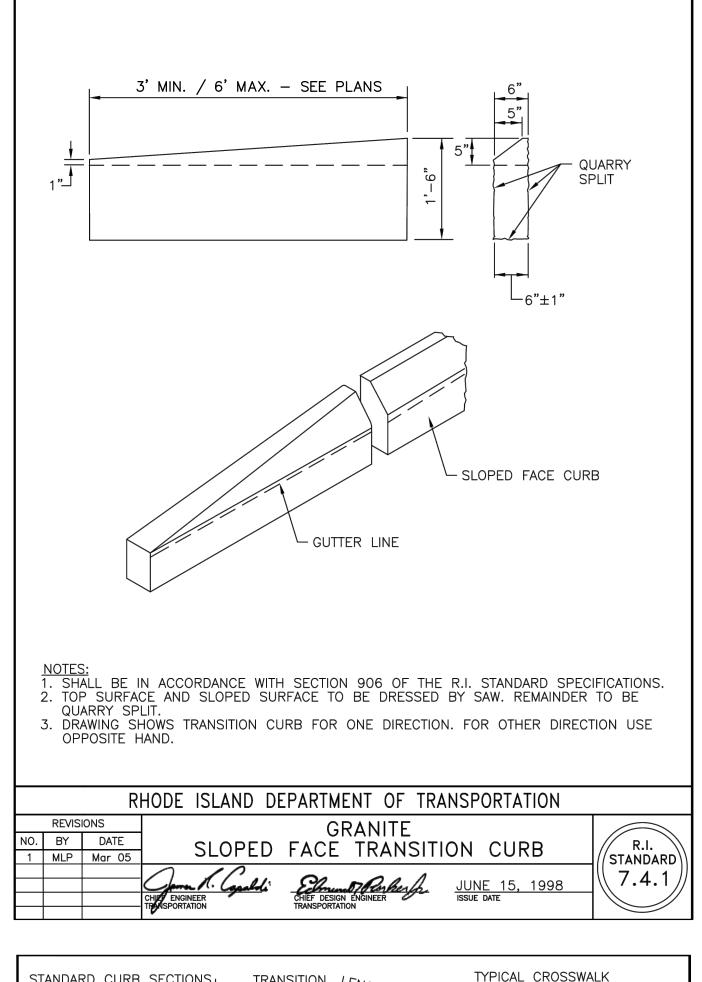


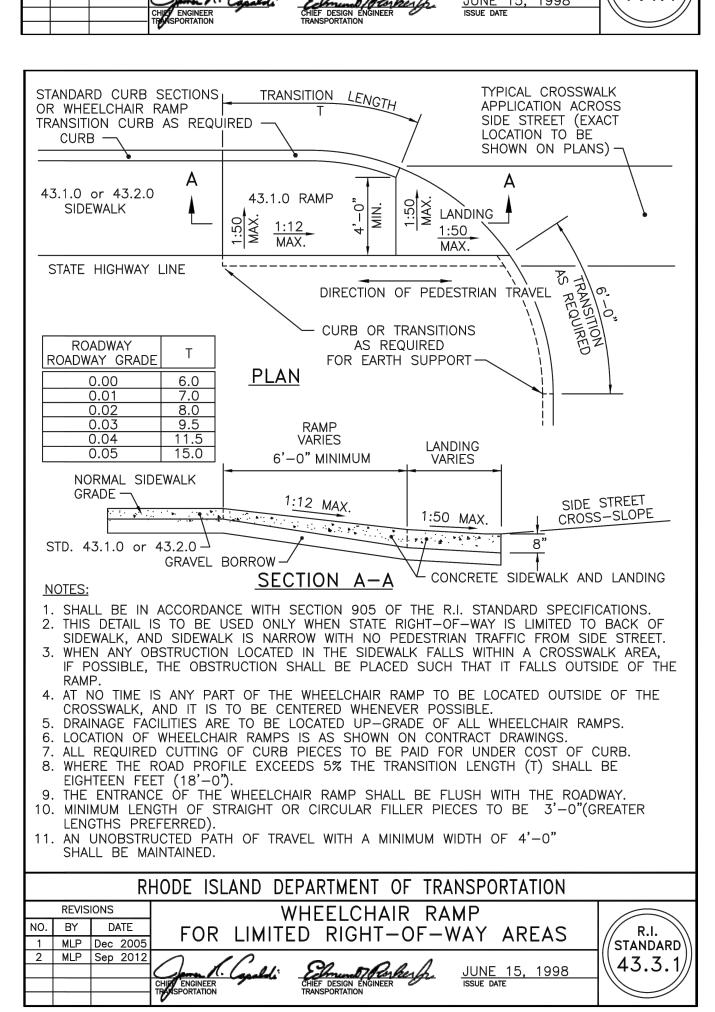

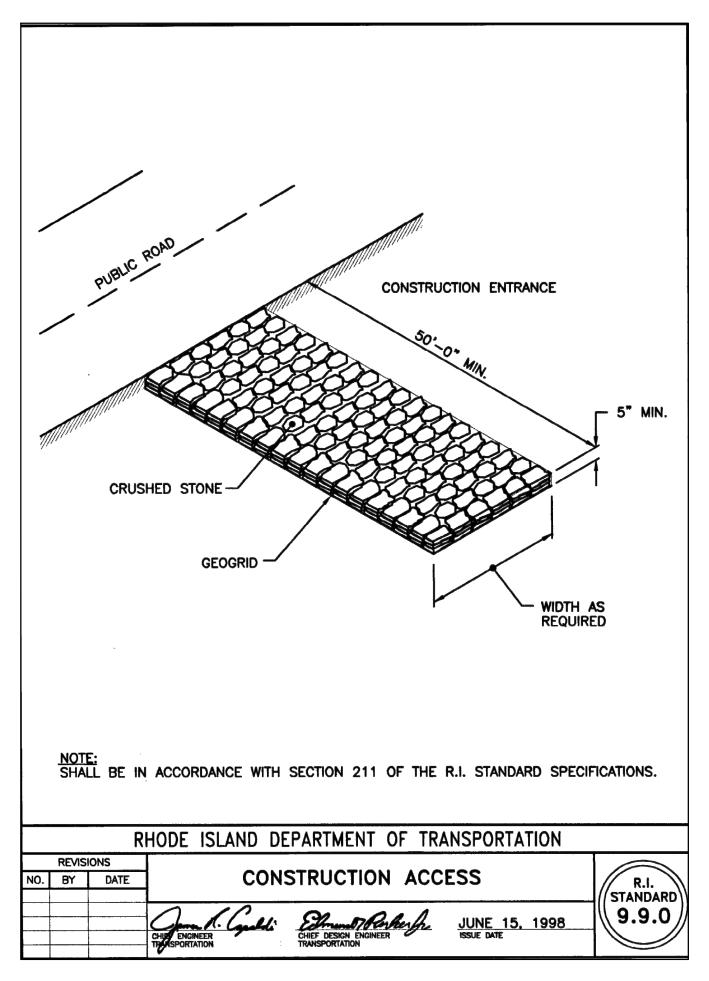

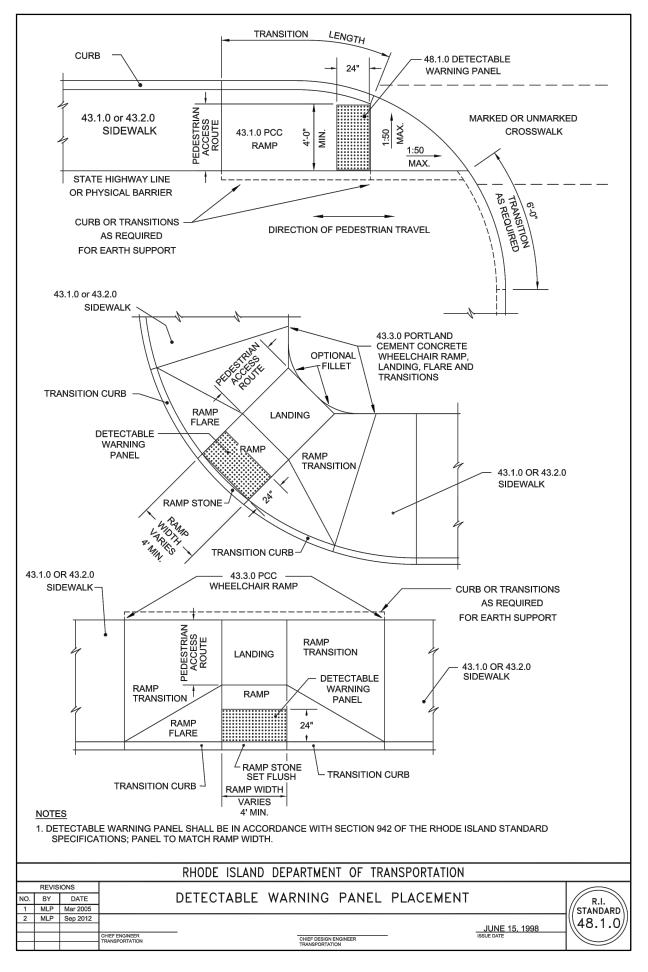


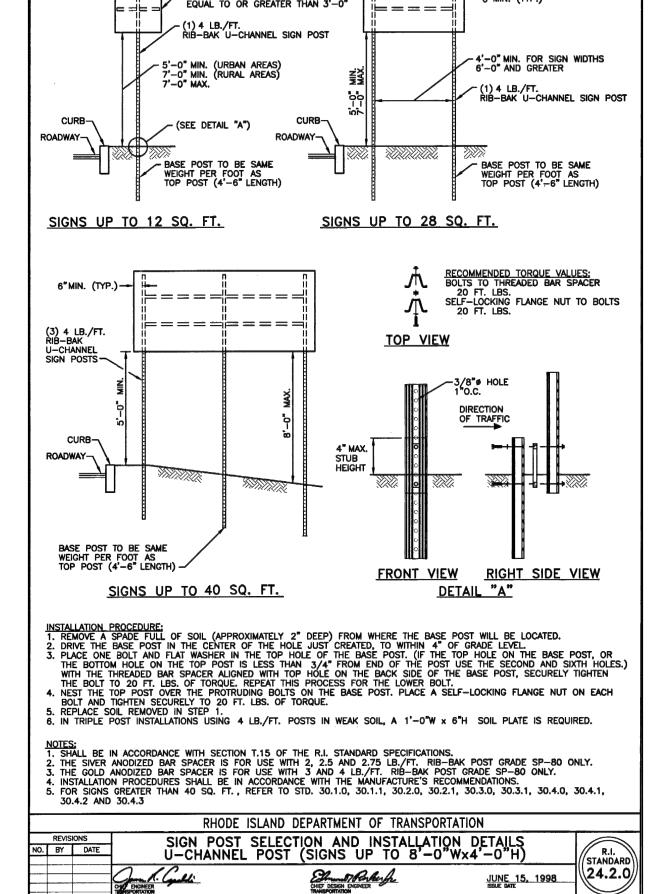

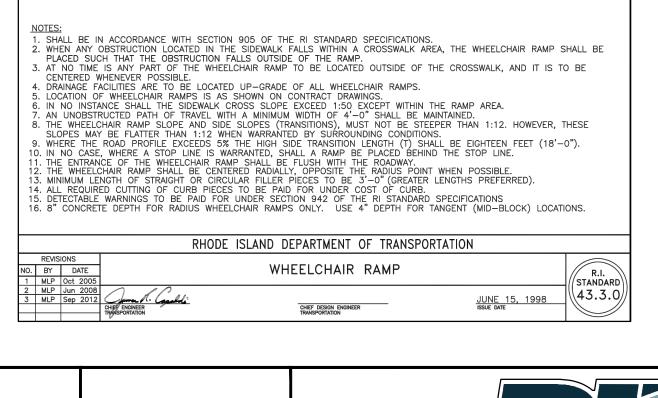





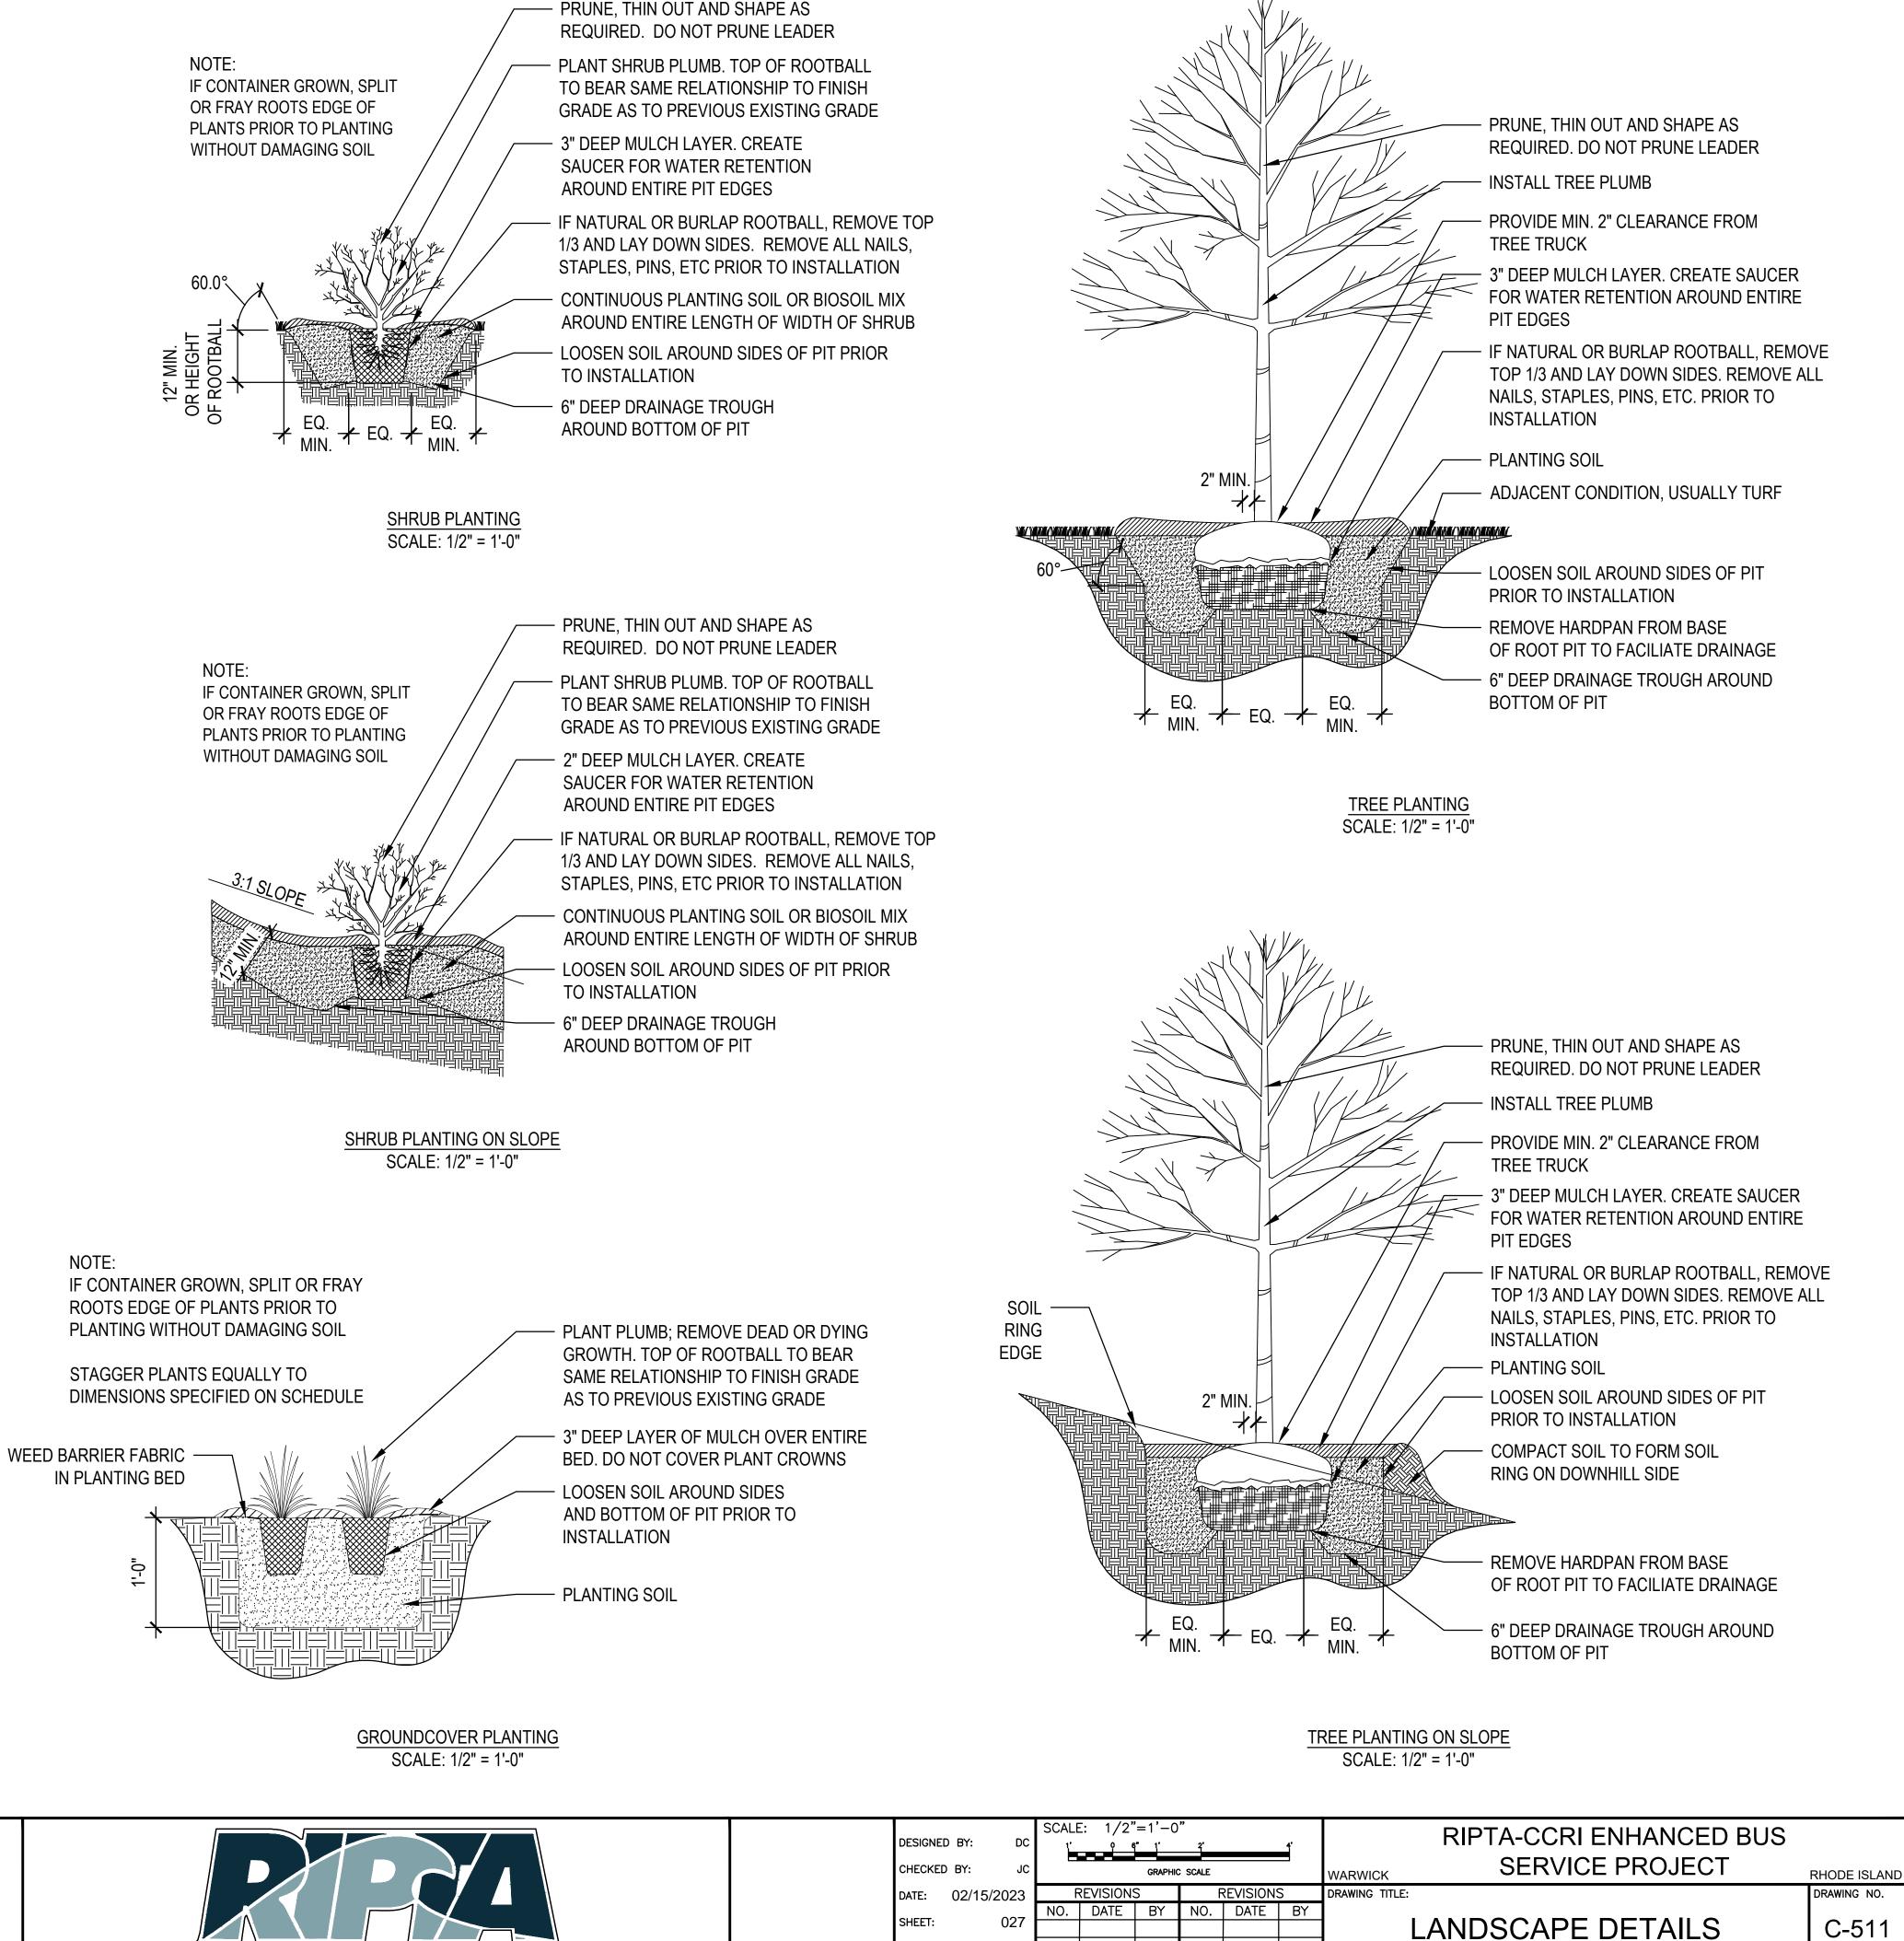

OF:

Michael Baker INTERNATIONAL MBAKERINTL.COM

EQ. EQ.

SPACING "A" (SEE PLANT

6" o.c.

8" o.c.

12" o.c.

18" o.c.

24" o.c.

30" o.c.

36" o.c.

48" o.c.

LIST -NOTES

COLUMN)

ROW "B"

5.20"

6.93"

10.40"

15.60"

20.80"

25.40"

29.70"

39.60"

GROUNDCOVER SPACING CHART

SCALE: 1/2" = 1'-0"

NUMBER OF PLANTS

PER SQUARE FOOT

4.00

2.60

1.00

0.45

0.25

0.16

0.11

0.0625

56 Exchange Terrace

Providence, RI 02903

4th Floor, Suite 400

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